W.P. W.R. WIN. W/ WD.

WATERPROOF

WINDOW

WOOD

WATER RESISTANT

HEIGHT

HORIZONTAL

HK. HORIZ. HYD.

PLANNING

PROJECT DESCRIPTION: EXTERIOR/INTERIOR REMODEL SINGLE-FAMILY RESIDENCE

ACRES: 2.03 ZONING: AR-10 (EASTERN) ZONING: RS-20 (WESTERN PORTION) CONSTRUCTION TYPE: VB OCCUPANCY GROUP: RESIDENTIAL FIRE PROTECTION: NONE NUMBER OF STORIES: TWO STORY

RESIDENCE, FINISHED BASEMENT, ONE

SETBACKS AS PER PITKIN COUNTY, SEE

PLANNING SHEET

#### BUILDING

STORY GARAGE

Pitkin County Currently Adopted Codes. The client will conform with 2018 IECC (Assemblies and Fenestration) and the updated land use code for Energy Efficiency on Earth Day 2020.

2015 International Building Code 2015 International Residential Code 2015 International Mechanical Code 2015 International Plumbing Code 2015 International Fuel & Gas Code 2015 International Energy Conservation Code Pitkin County Efficient Building Code Most Current National Electrical Code

Snow-load: 40 PSF, Up to 7000' Elevation, Elevation is TBC'

100' as per Civil = TBC'

Roof Duration = 1.0

Seismic Design Category = B or C, as per Figure R301.2 (2) As per soil design

Weathering probability for Concrete = Severe

Termite Infestation Probability = None to slight

Wind Speed = 115 mph (ultimate design)

Wind Exposure = B or C, Section R301.2.1.4

Frost Depth = 36" (up to 7000' Elevation)

Air Freezing Index = 2500° F Days – Up to 7000 ft. elevation

Ice Barrier Underlayment = Required

Mean Annual Temp = variable

Insulation = as per Minimum R-Values per 2009 IECC, Table 402.1.1, Client chooses to utilize stricter minimums as per 2018 IECC for thermal comfort and energy efficiency.

As per State House Bill 09-1091, CO alarms are required within 15 feet of all sleeping



Rainbow pencil study exterior front

1. CONTRACTOR TO COMPLY WITH CODES, LAWS, ORDINANCES, RULES, AND REGULATIONS OF

2. CONTRACTOR TO REVIEW DOCUMENTS, VERIFY DIMENSIONS AND FIELD CONDITIONS AND CONFIRM THAT WORK IS BUILDABLE AS SHOWN. CONTRACTOR TO REPORT ANY CONFLICTS OR OMISSIONS TO THE ARCHITECT FOR CLARIFICATION PRIOR TO PERFORMING ANY WORK IN QUESTION.

3. FOR SUBSTITUTIONS, REFER TO THE SPECIFICATIONS.

PUBLIC AUTHORITIES GOVERNING THE WORK.

4. DO NOT SCALE DRAWINGS. DIMENSIONS SHALL TAKE PRECEDENCE OVER SCALES SHOWN ON DRAWINGS, GENERAL CONTRACTOR SHALL VERIFY ALL DIMENSIONS, GRADES AND CONDITIONS AT SITE PRIOR TO COMMENCING THE WORK.

5. MAINTAIN DIMENSIONS MARKED 'CLEAR'. ALLOW FOR THICKNESS OF FINISHES.

CEILING HEIGHT DIMENSIONS ARE TO FINISHED SURFACES.

ARCHITECT BEFORE PROCEEDING WITH THE WORK.

7. CONTRACTOR TO COORDINATE AND PROVIDE BACKING FOR MILLWORK AND ITEMS ATTACHED OR MOUNTED TO WALLS OR CEILINGS.

8. EXCEPT WHERE SHOWN IN DIMENSIONAL DETAIL, THE LOCATIONS OF PLUMBING, MECHANICAL EQUIPMENT, DUCTS, PIPING AND FITTINGS ARE ONLY APPROXIMATE. THE EXACT LOCATIONS SHALL BE DETERMINED BY THE CONTRACTOR, SUBJECT TO APPROVAL BY THE ARCHITECT.

9. CONTRACTOR SHALL PROVIDE AND INSTALL ALL STIFFENERS, BRACING, BLOCKING, AND SUPPORTING BRACKETS REQUIRED FOR THE INSTALLATION OF ALL CASEWORK, TOILET ROOM ACCESSORIES, FIXTURES AND PARTITIONS AND ALL WALL MOUNTED OR SUSPENDED MECHANICAL, ELECTRICAL OR MISCELLANEOUS EQUIPMENT AND FURNISHINGS.

10. ALL WORK PERFORMED SHALL COMPLY WITH THE CONTRACT DOCUMENTS, DRAWINGS, SPECIFICATIONS, AND GEOTECHNICAL INVESTIGATION AND PAVEMENT RECOMMENDATIONS.

11. SPECIFICATIONS, BOUND SEPARATELY, ARE PART OF THE CONTRACT DOCUMENTS. 12. ALL MATERIALS AND WORKMANSHIP SHALL CONFORM TO THE DRAWINGS AND SPECIFICATIONS. IF CONFLICT IS FOUND BETWEEN DRAWINGS, GENERAL NOTES AND SPECIFICATIONS, CONSULT THE

13. THE STRUCTURAL, MECHANICAL AND ELECTRICAL DRAWINGS ARE SUPPLEMENTARY TO THE ARCHITECTURAL DRAWINGS. IT SHALL BE THE RESPONSIBILITY OF THE CONTRACTOR TO CHECK WITH THE ARCHITECTURAL DRAWINGS BEFORE THE INSTALLATION OF STRUCTURAL, MECHANICAL AND ELECTRICAL WORK. SHOULD THERE BE A DISCREPANCY BETWEEN THE ARCHITECTURAL DRAWINGS AND THE CONSULTING ENGINEERS' DRAWINGS THAT WOULD CAUSE AN AWKWARD INSTALLATION, IT SHALL BE BROUGHT TO THE ARCHITECT'S AND ENGINEERS' ATTENTION FOR CLARIFICATION PRIOR TO THE INSTALLATION OF SAID WORK.

14. GENERAL NOTES ARE NOT A SUBSTITUTE NOR A REPLACEMENT FOR THE PROJECT SPECIFICATIONS. THESE NOTES ARE INTENDED AS A GUIDE TO THE DESIGN AND/OR CONSTRUCTION REQUIREMENTS ESTABLISHED FOR THIS PROJECT.

15. NO CONTRACTOR SHOULD ATTEMPT TO BID OR CONSTRUCT ANY PORTION OF THE WORK WITHOUT CONSULTING THE PROJECT SPECIFICATIONS.

16. THE CONTRACTOR SHALL COORDINATE THE INTENT OF THE GENERAL NOTES WITH ALL TRADES

## TABLE C402.1.3 OPAQUE THERMAL ENVELOPE INSULATION COMPONENT MINIMUM REQUIREMENTS, R-VALUE METHODA!

CLIMATE		1		2	3		4 EXCEPT MARINE		5 AND MARINE 4		6			7		8
ZONE	All other	Group R	All other	Group R	All other	Group R	All other	Group R	All other	Group R	All other	Group R	All other	Group R	All other	Group R
	Roofs															
Insulation entirely above roof deck	R-20ci	R-25ci	R-25ci	R-25ci	R-25ci	R-25ci	R-30ci	R-30ci	R-30ci	R-30ci	R-30ci	R-30ci	R-35ci	R-35ci	R-35ci	R-35ci
Metal buildings <sup>b</sup>	R-19 + R-11 LS	R-19 + R-11 LS	R-19 + R11 LS	R-19 + R-11 LS	R-19 + R-11 LS	R-19 + R-11 LS	R-19 + R-11 LS	R-19 + R-11 LS	R-19 + R-11 LS	R-19 + R-11 LS	R-25 + R-11 LS	R-25 + R-11 LS	R-30 + R-11 LS	R-30 + R-11 LS	R-30 + R-11 LS	R-30 + R-11 LS
Attic and other	R-38	R-38	R-38	R-38	R-38	R-38	R-38	R-38	R-38	R-49						
							Walls,	above grad	e							
Mass <sup>o</sup>	R-5.7cf	R-5.7d°	R-5.7cf	R-7.6d	R-7.6d	R-9.5ci	R-9.5ci	R-11.4ci	R-11.4d	R-13.3ci	R-13.3d	R-15.2ci	R-15.2d	R-15.2d	R-25d	R-25d
Metal building	R-13+ R-6.5d	R-13 + R-6.5ci	R13 + R-6.5d	R-13 + R-13d	R-13 + R-6.5d	R-13 + R-13ci	R-13 + R-13d	R-13 + R-13ci	R-13 + R-13ci	R-13 + R-13d	R-13 + R-13ci	R-13 + R-13ci	R-13 + R-13ci	R-13+ R-19.5di	R-13 + R-13ci	R-13+ R-19.5ci
Metal framed	R-13 + R-5d	R-13 + R-5ci	R-13 + R-5d	R-13 + R-7.5d	R-13 + R-7.5d	R-13 + R-7.5di	R-13 + R-7.5ci	R-13 + R-7.5ci	R-13 + R-7.5di	R-13 + R-7.5ci	R-13 + R-7.5ci	R-13 + R-7.5d	R-13 + R-7.5ci	R-13 + R-15.6d	R-13 + R-7.5ci	R-13+ R17.5d
Wood framed and other	R-13 + R-3.8di or R-20	R-13 + R-3.8ci or R-20	R-13 + R-3.8di or R-20	R-13 + R-3.8ci or R-20	R-13 + R-3.8ci or R-20	R-13 + R-3.8di or R-20	R-13 + R-3.8ci or R-20	R-13 + R-3.8d or R-20	R-13 + R-3.8di or R-20	R-13 + R-7.5d or R-20 + R-3.8d	R-13 + R-7.5ci or R-20 + R-3.8ci	R-13 + R-7.5d or R-20 + R-3.8d	R-13 + R-7.5ci or R-20 + R-3.8ci	R-13 + R-7.5cl or R-20 + R-3.8ci	R13 + R-15.6ci or R-20 + R-10ci	R13 + R-15.6ci o R-20 + R-10ci
							Walls,	below grad	e							
Below-grade walf <sup>d</sup>	NR	NR	NR	NR	NR	NR	R-7.5ci	R-7.5ci	R-7.5ci	R-7.5ci	R-7.5ci	R-7.5ci	R-10ci	R-10ci	R-10ci	R-12.5ci
								Floors								
Mass*	NR	NR	R-6.3ci	R-8.3ci	R-10ci	R-10ci	R-10ai	R-10.4ci	R-10ci	R-12.5ci	R-12.5ci	R-12.5ci	R-15ci	R-16.7ci	R-15ci	R-16.7ci
Joist/framing	NR	NR	R-30	R-30	R-30	R-30	R-30	R-30	R-30	R-30	R-30	R-30 <sup>f</sup>				
	Slab-on-grade floors															
Unheated slabs	NR	NR	NR	NR	NR	NR	R-10 for 24' below	R-10 for 24° below	R-10 for 24' below	R-10 for 24° below	R-10 for 24° below	R-15 for 24' below	R-15 for 24° below	R-15 for 24° below	R-15 for 24' below	R-20 for 24° below
Heated slabs <sup>h</sup>	R-7.5 for 12' below + R-5 full slab	R-10 for 24' below + R-5 full slab	R-10 for 24' below + R-5 full slab	R-15 for 24' below + R-5 full slab	R-15 for 24° below + R-5 full slab	R-15 for 36' below + R-5 full slab	R-15 for 36' below + R-5 full slab	R-15 for 36* below + R-5 full slab	R-20 for 48' below + R-5 full slab	R-20 for 48° below + R-5 full slab	R-20 for 48' below + R-5 full slab	R-20 for 48' below + R-5 full slab	R-20 for 48' below + R-5 full slab			

IECC 2018 Taable C402.1.3

A110 A111 A112 A114 A115 A120 A121 A122 A123 A200 A201

G1

C1

A101

A102

A103

A105

**Elevations New** A203 **Elevations New** A300 Sections- Longitudinal A301 Sections- Transverse A302 Sections- Transverse A400 Interior Elevations A401 Interior Elevations A402 Interior Elevations

SHEET INDEX

Improvement Survey Plat

Architectural Site Plan

**Existing Basement** 

**Existing Main Level** 

**Existing Upper Level** 

Planning Analysis

**Demo Basement** 

Demo Main Level

Demo Upper Level

**Proposed Basement** 

Proposed Main Level

Proposed Upper Level

Propsosed Roof

**Elevations Existing** 

**Elevations Existing** 

Demo Roof

Cover Sheet

Roof Plan

A403 Interior Elevations A404 Interior Elevations A405 Interior Elevations A406 Interior Elevations A407 Interior Elevations

A500 Schedules A501 Schedules A502 **Door Schedules** 

TABLE C402.4

Vertical fenestration

0.46

0.60

0.77

0.55

0.35

4 EXCEPT

MARINE

0.38

0.45

0.77

0.50

0.40

a. "N" indicates vertical fenestration oriented within 45 degrees of true north. "SEW" indicates orientations other than "N." For buildings in the southern hemisphere, reverse south and north. Buildings

SEW N SEW N

0.25 | 0.33 | 0.25 | 0.33 | 0.25 | 0.33 | 0.36 | 0.48 | 0.38 | 0.51 | 0.40 | 0.53 | 0.45 | NR | 0.45 | N

0.30 | 0.37 | 0.30 | 0.37 | 0.30 | 0.37 | 0.43 | 0.53 | 0.46 | 0.56 | 0.48 | 0.58 | NR | NR | NR | NR

0.40 | 0.40 | 0.40 | 0.40 | 0.40 | 0.40 | 0.58 | 0.58 | 0.61 | 0.61 | 0.64 | 0.64 | NR | NR | NR

A600 Assemblies and Energy Use A601 3" Details A700 Renderings

5 AND

MARINE 4

0.38

0.45

0.77

0.50

0.40

0.36

0.43

0.77

0.50

0.40

Jennifer and Joseph Mason BUILDING ENVELOPE FENESTRATION MAXIMUM U-FACTOR AND SHGC REQUIREMENTS

0.29

0.37

0.77

0.50

NR

0.29

0.37

0.77

NR

264308100010 Parcel ID R003195 Account #

041 Rainbow Lane

41 Rainbow Lane Woody Creek

CO 81656 M/B Woody Creek

cloud hill

design, llc

Cloud Hill Design, LLC

Snowmass CO 81654 USA

INTEGRATED DESIGN TEAM

Design Travis Terry Design, Terry I Mc Manamon

General Contractor

Structural Engineer

Brian Rossitor, PE

Peak Surveying Ind Jason R. Neil, P.L.S

Planning and Design Cloud Hill Design, LLC

Jeffrey Woodruff

David Griesser

Travis Terry

Issue: 11/18/2021 Planning Pre-Application Schematic/Pricing 01/14/2022 01/18/2022 **Building Pre-Application** 

G1

located at less than 23.5 degrees latitude shall use SEW for all orientations.

**SOURCE:** 2018 International Energy Conservation Code

0.50

0.65

1.10

0.75

0.35

0.50

0.65

0.83

0.65

0.35

CLIMATE ZONE

NR = No Requirement, PF = Projection Factor.

https://tinyurl.com/vfew22e

U-factor

Fixed fenestration

Entrance doors SHGC

Orientationa

0.2 ≤ PF < 0.5

PF < 0.2

PF ≥ 0.5

U-factor

SHGC

Operable fenestration

Client to meet IECC 2018 Table 402.4 Building Envelope and Fenestration Maximum U-Factor and SHGC Requirements. (As per table below, C402.4)

Client to meet Insulation = as per Minimum R-Values per 2018 IECC, Table 402.1.3, client chooses to utilize stricter minimums as per 2018 IECC for Climate Zone 7. Attic and other R-Value method = R-49


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Cover Sheet



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INTEGRATED DESIGN TEAM

General Contractor David Griesser

Design Travis Terry Design, Terry I Mc Manamon Travis Terry

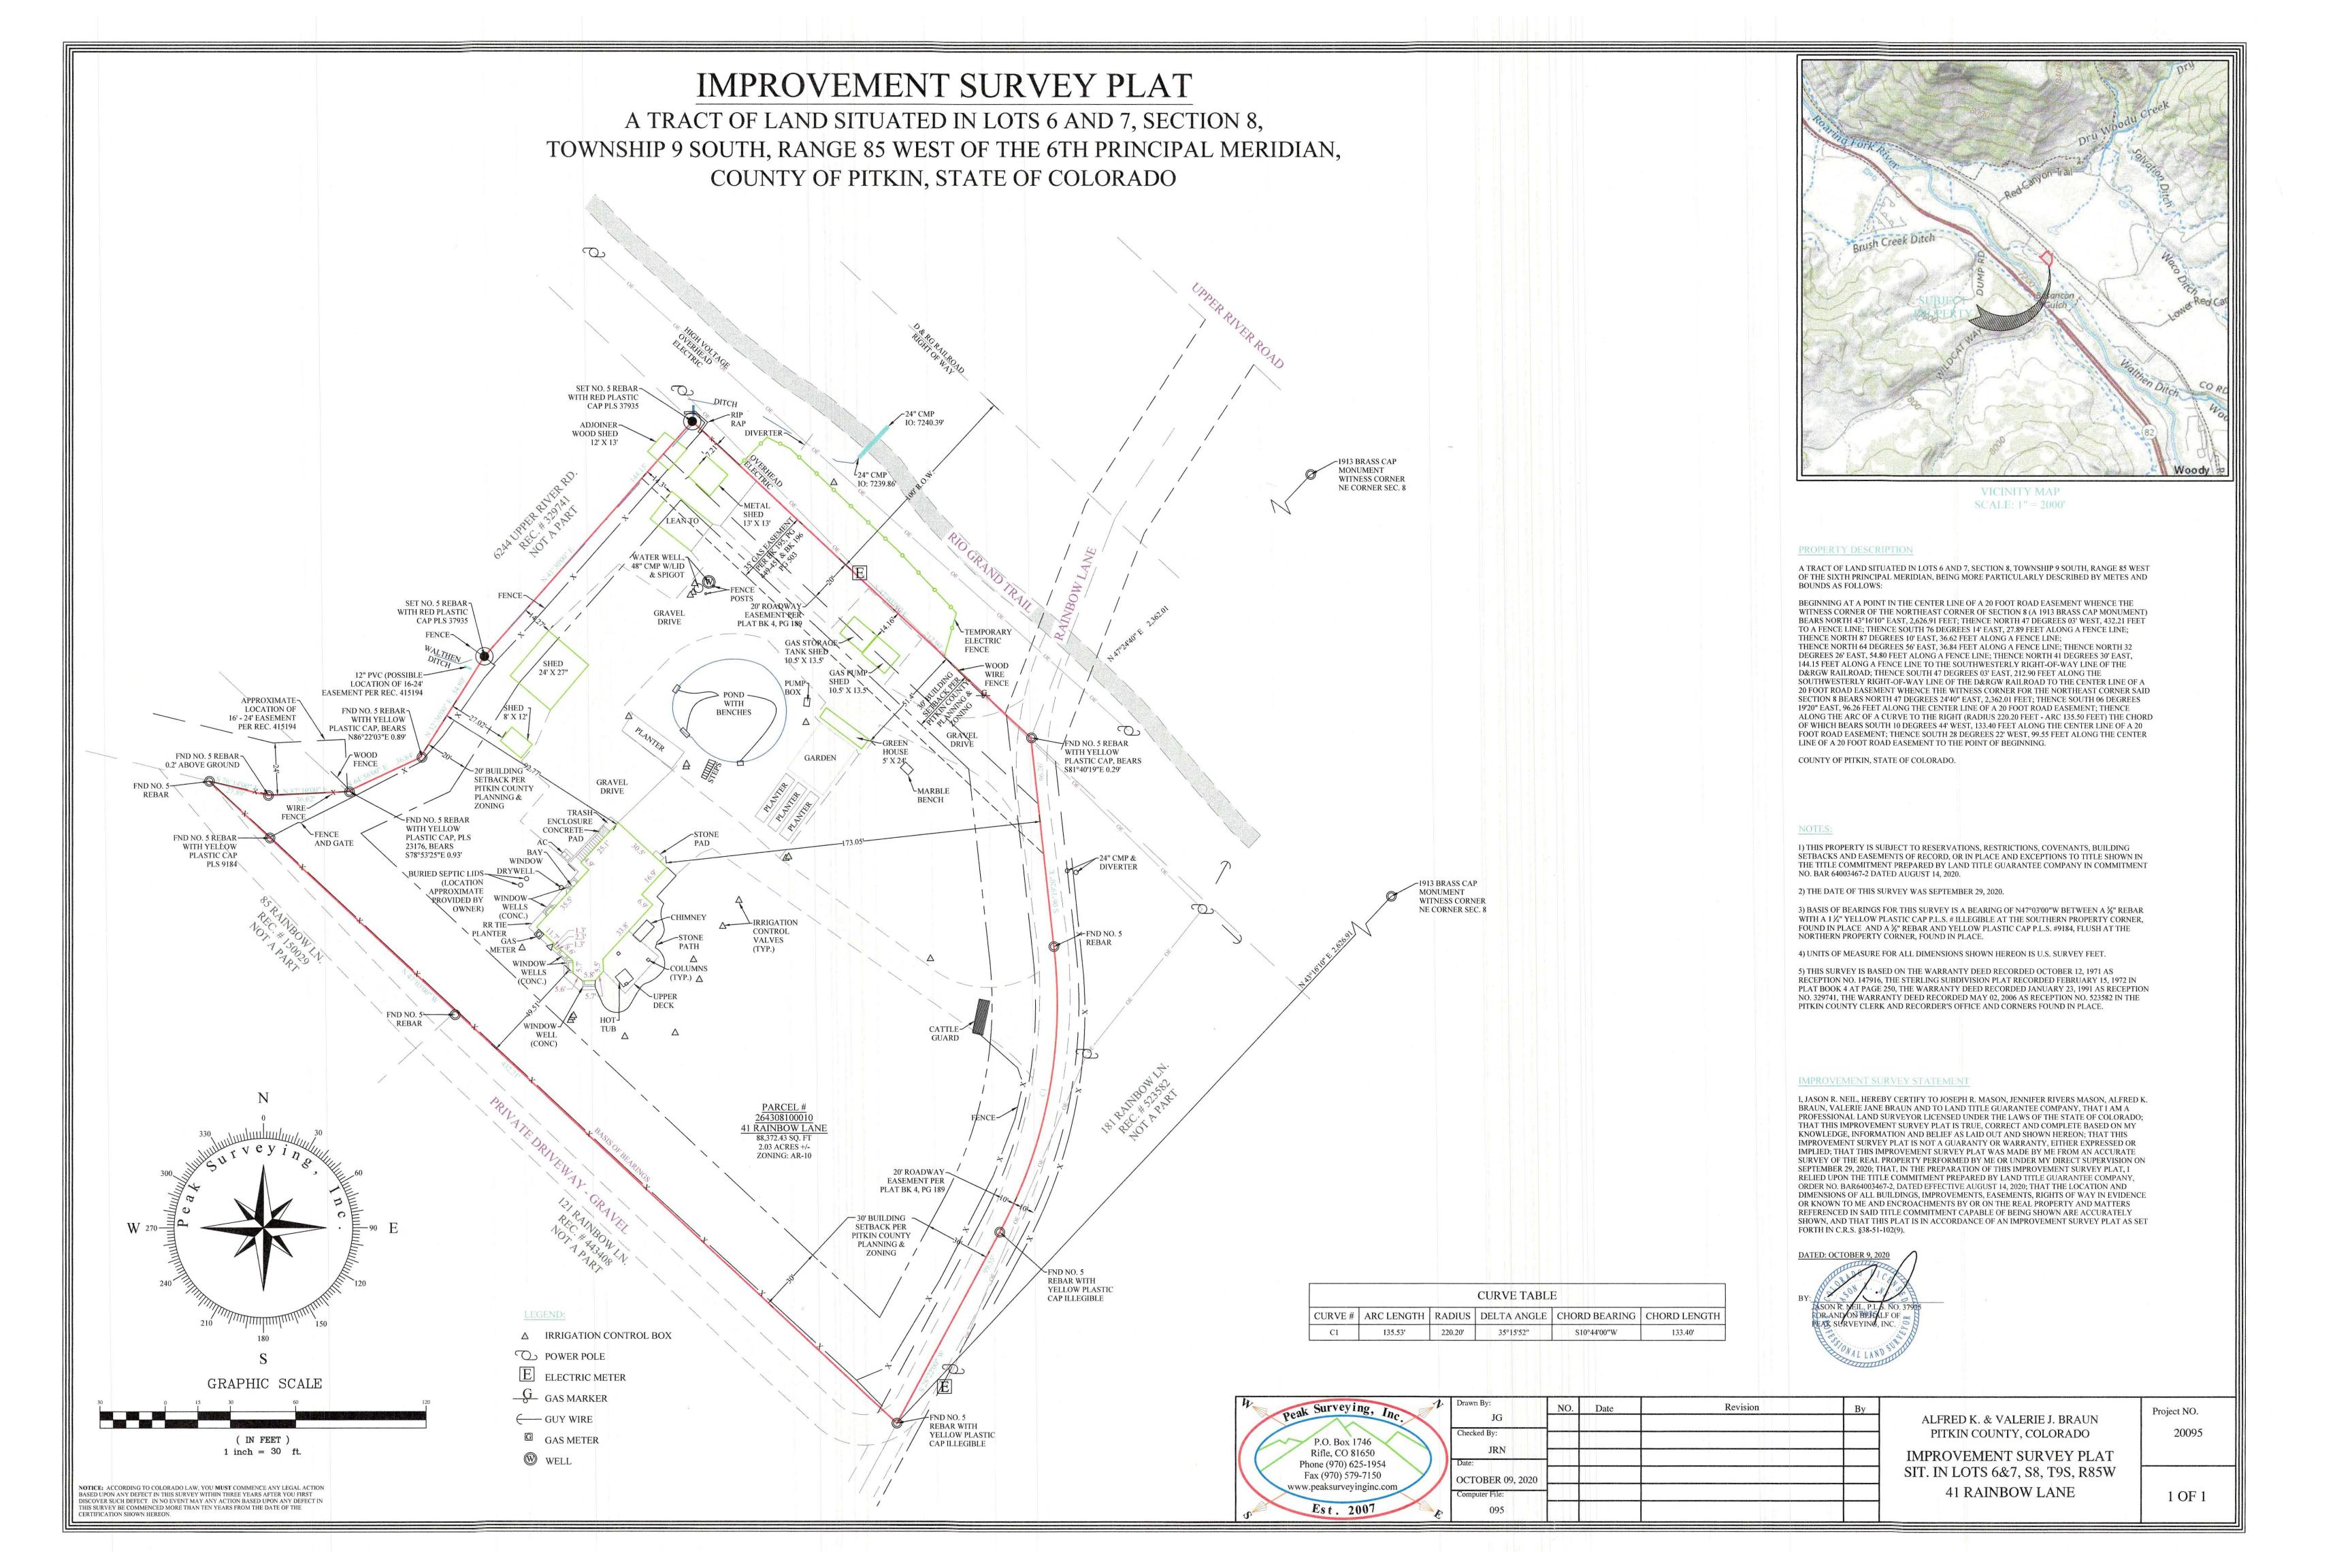Structural Engineer Brian Rossitor, PE

Survey Peak Surveying Inc. Jason R. Neil, P.L.S.

Planning and Design Cloud Hill Design, LLC Jeffrey Woodruff

041 Rainbow Lane

41 Rainbow Lane Woody Creek CO 81656 M/B Woody Creek

Jennifer and Joseph Mason

Parcel ID 264308100010 Account # R003195

Date: Issue:

11/18/2021 Planning Pre-Application

01/14/2022 Schematic/Pricing

01/18/2022 Building Pre-Application

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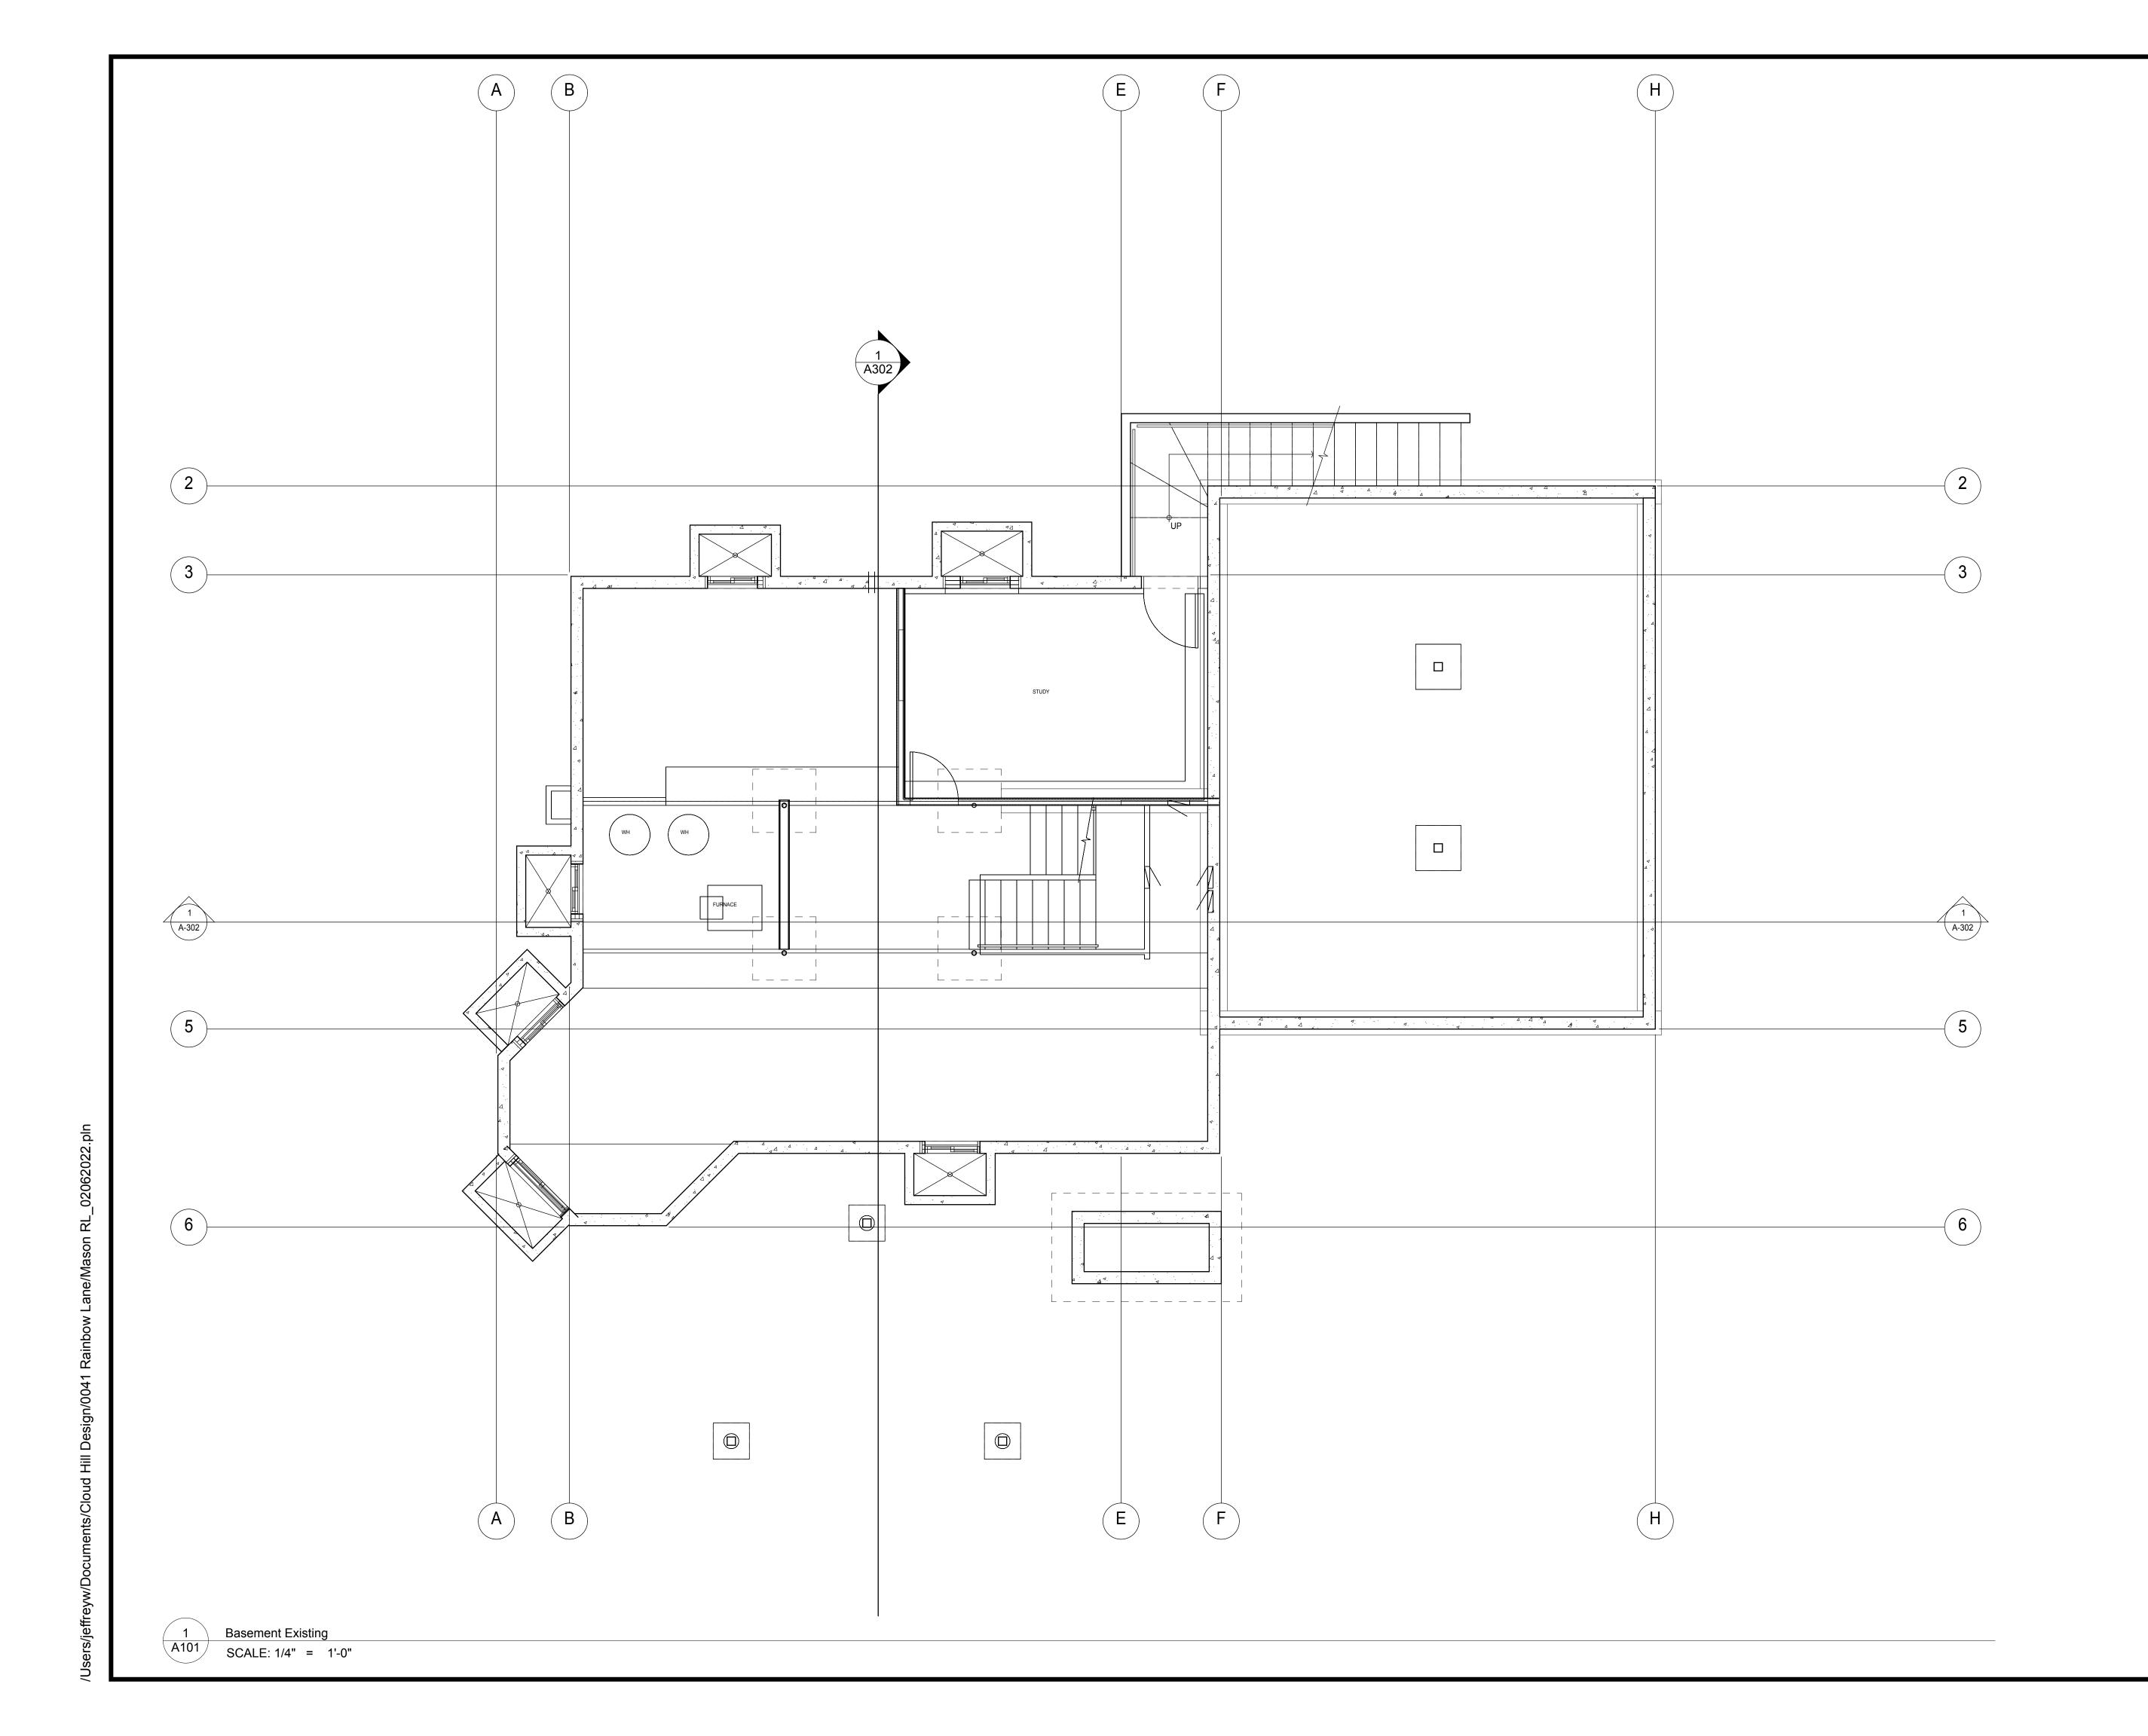
SHEET TITLE

Architectural Site Plan

A100

architectural site

SCALE: 1/16" = 1'-0"



Cloud Hill Design, LLC Snowmass CO 81654 USA

INTEGRATED DESIGN TEAM

General Contractor David Griesser

Design Travis Terry Design, Terry I Mc Manamon Travis Terry

Structural Engineer Brian Rossitor, PE

Survey Peak Surveying Inc. Jason R. Neil, P.L.S.

Planning and Design Cloud Hill Design, LLC Jeffrey Woodruff

041 Rainbow Lane

41 Rainbow Lane Woody Creek CO 81656 M/B Woody Creek

Jennifer and Joseph Mason

Parcel ID 264308100010 Account # R003195

Date: Issue:
11/18/2021 Planning Pre-Application
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01/18/2022 Building Pre-Application

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SHEET TITLE

**Existing Basement** 

A101

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General Contractor David Griesser

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Structural Engineer Brian Rossitor, PE

Survey Peak Surveying Inc. Jason R. Neil, P.L.S.

Planning and Design Cloud Hill Design, LLC Jeffrey Woodruff

# 041 Rainbow Lane

41 Rainbow Lane Woody Creek CO 81656 M/B Woody Creek

Jennifer and Joseph Mason

264308100010

Account # R003195

Dat	e:	Issue:
11/	18/2021	Planning Pre-Application
01/	14/2022	Schematic/Pricing
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SHEET 5

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Existing Main Level

A102

SCALE: 1/4" = 1'-0"

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## INTEGRATED DESIGN TEAM

General Contractor David Griesser

Design Travis Terry Design, Terry I Mc Manamon Travis Terry

Structural Engineer Brian Rossitor, PE

Survey Peak Surveying Inc. Jason R. Neil, P.L.S.

Planning and Design Cloud Hill Design, LLC Jeffrey Woodruff

# 041 Rainbow Lane

41 Rainbow Lane Woody Creek CO 81656 M/B Woody Creek

Jennifer and Joseph Mason

264308100010 Parcel ID Account # R003195

Issue: Planning Pre-Application 11/18/2021 01/14/2022 Schematic/Pricing

**Building Pre-Application** 

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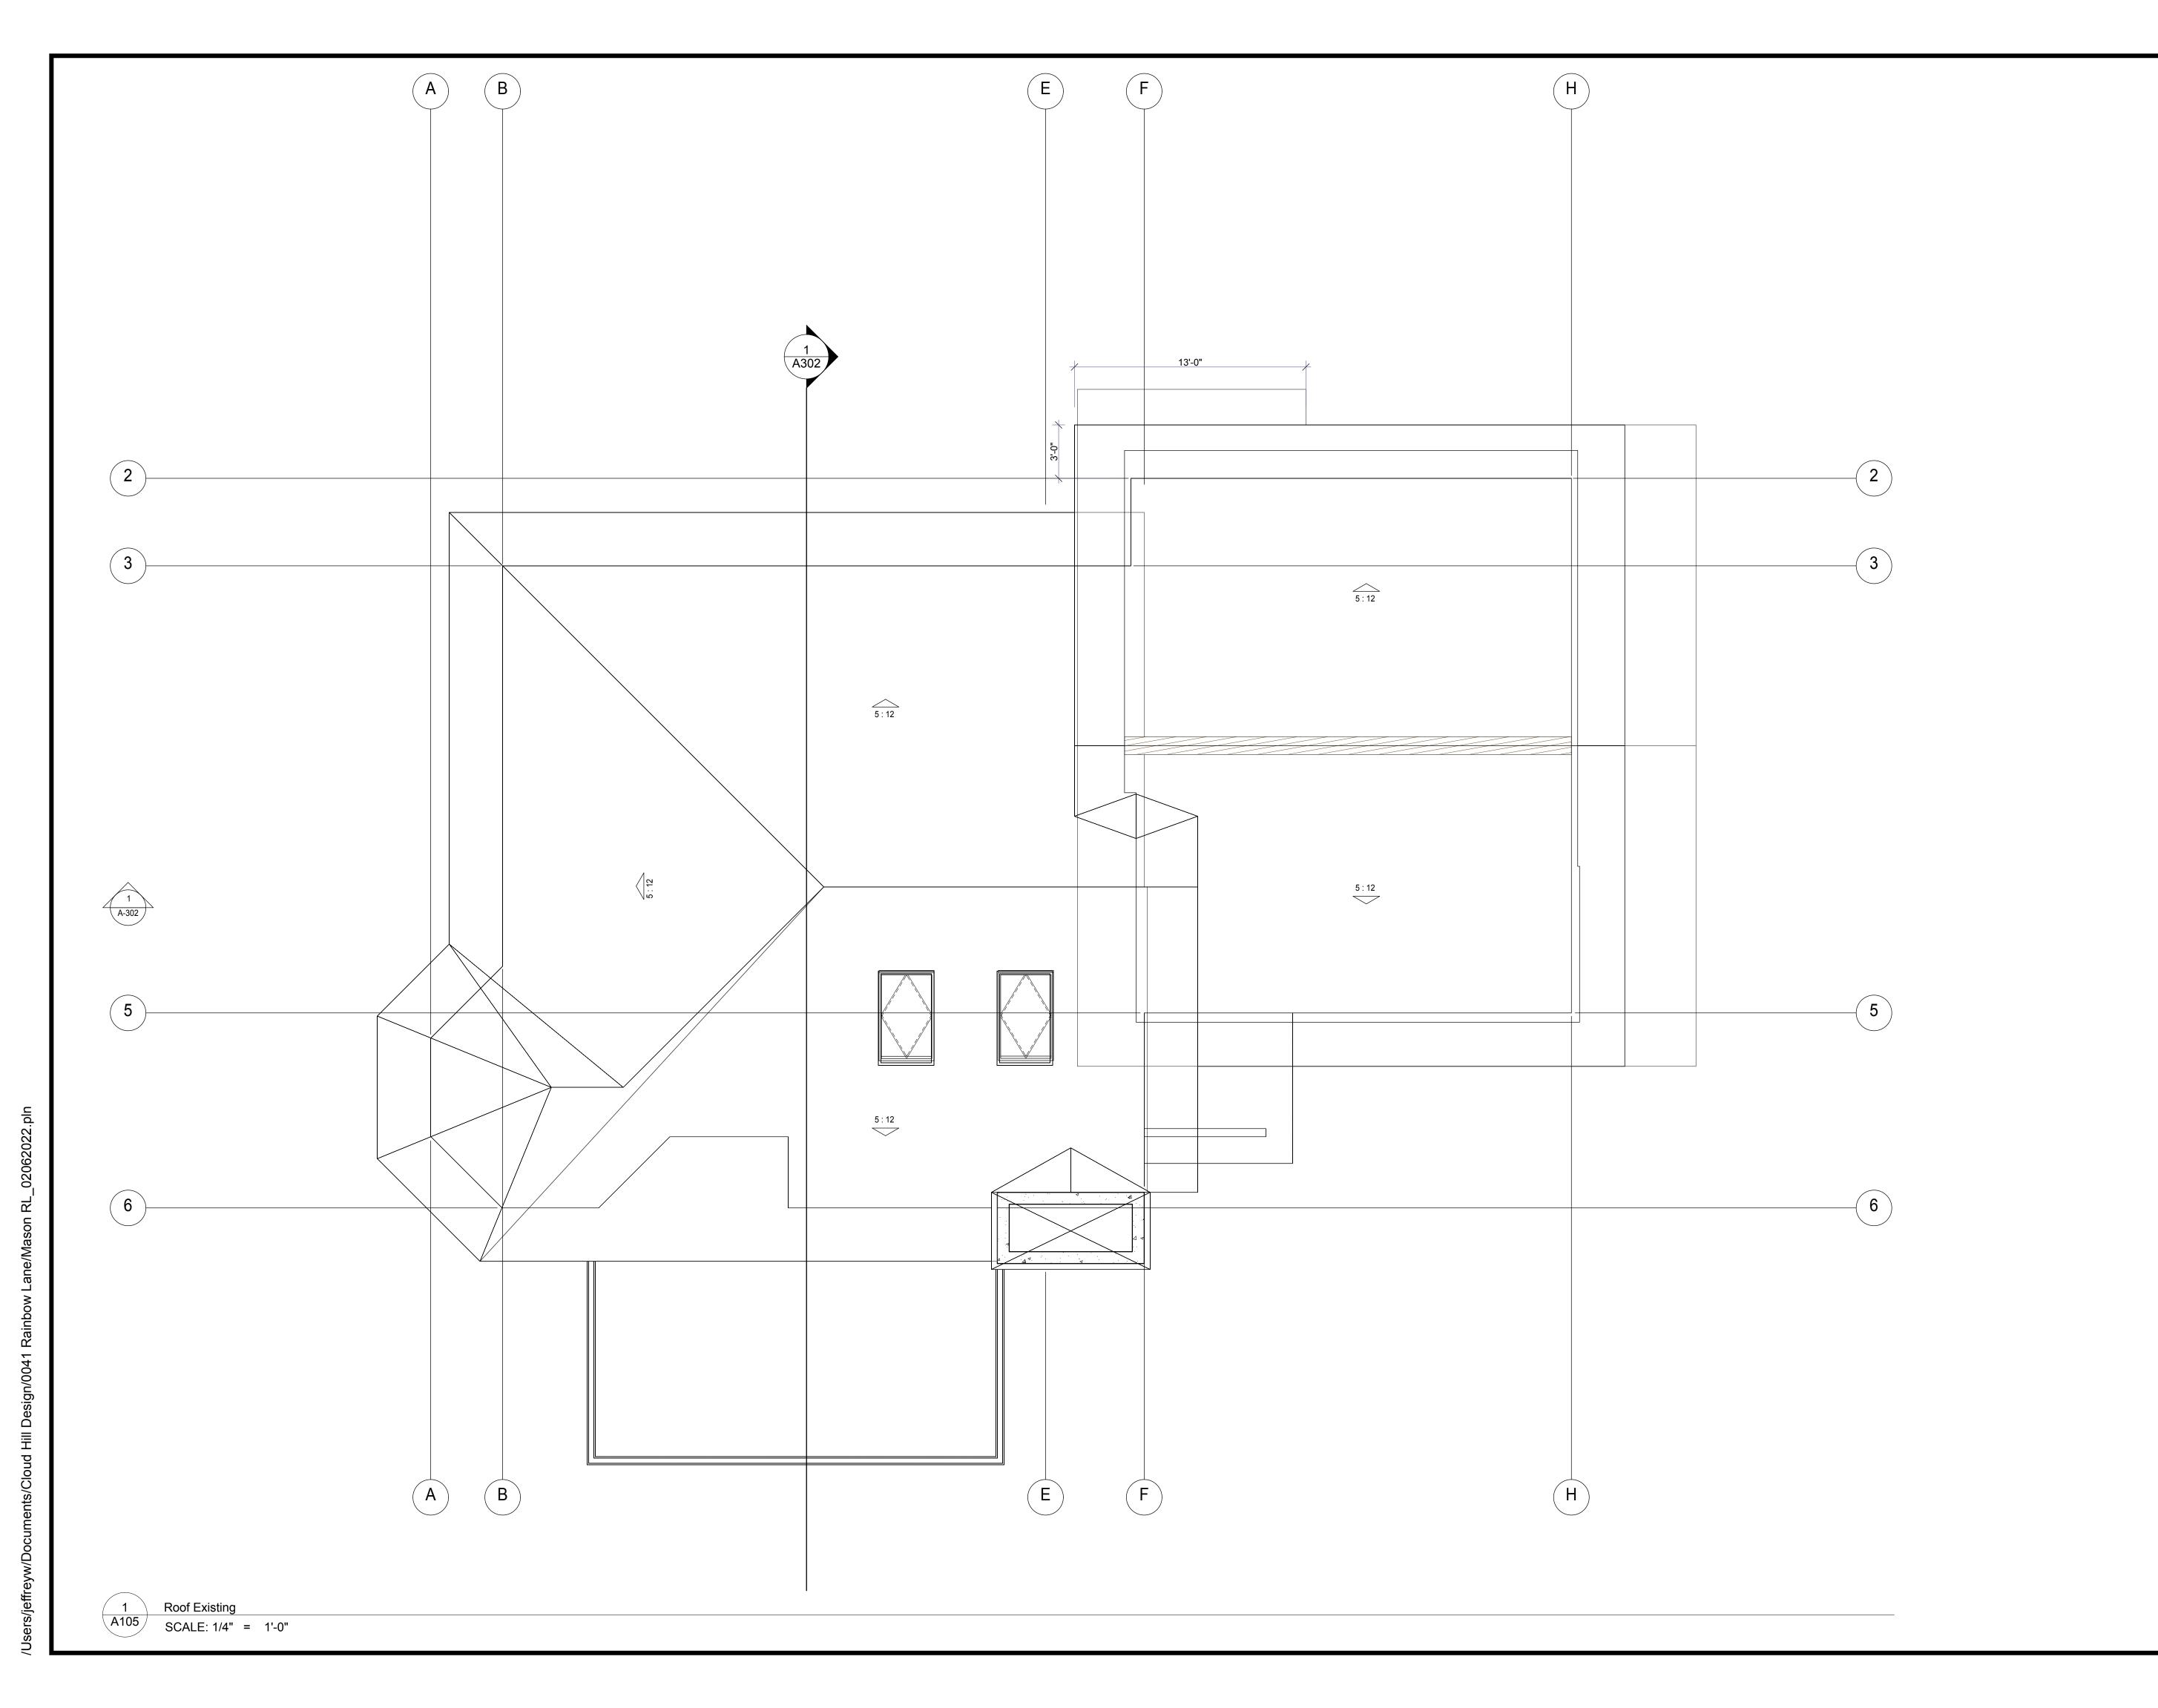
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**Existing Upper Level** 

A103



Cloud Hill Design, LLC Snowmass CO 81654 USA

INTEGRATED DESIGN TEAM

General Contractor David Griesser

Design Travis Terry Design, Terry I Mc Manamon Travis Terry

Structural Engineer Brian Rossitor, PE

Survey Peak Surveying Inc. Jason R. Neil, P.L.S.

Planning and Design Cloud Hill Design, LLC Jeffrey Woodruff

tomoy woodidii

041 Rainbow Lane

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Parcel ID 264308100010 Account # R003195

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11/18/2021 Planning Pre-Application
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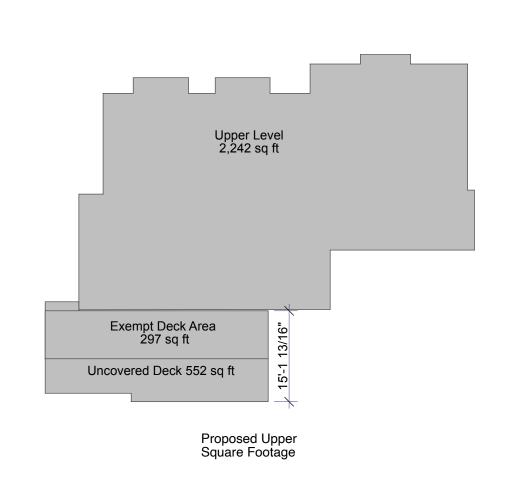
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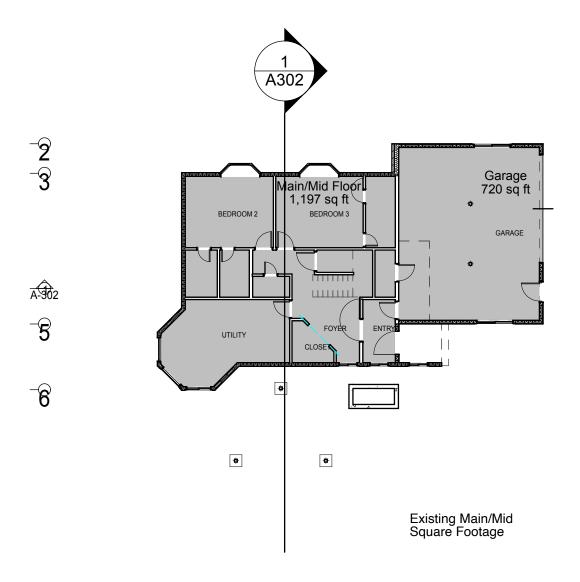
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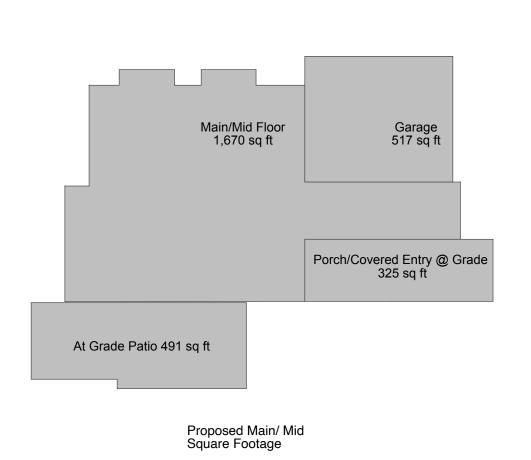
Roof Plan

A105





Upper Level Plan Floor Area SCALE: 1/16" = 1'-0"





Main/Mid Floor Floor Area SCALE: 1/16" = 1'-0"

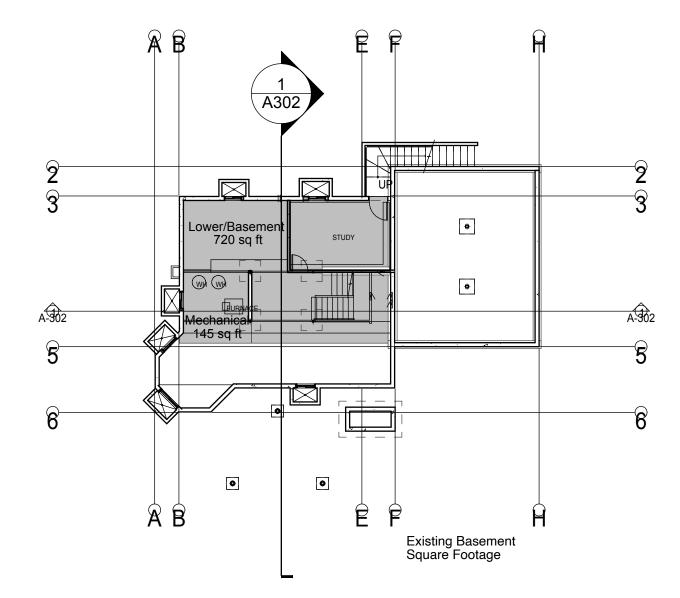

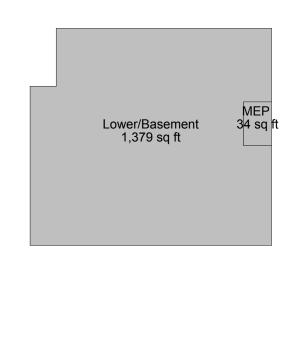

Proposed
Basement Square

Basement Floor Area SCALE: 1/16" = 1'-0"

Our application for a remodel of 41 Rainbow Rd is made in compliance with Pitkin County Land Use Code as adopted in 2006. This application if for a remodel of an existing residence built in 1989 and in receipt of a Certificate of Occupancy in 1990.

### The applicant is seeking approval from:

1. Pitkin County Planning for a remodel of an existing residence.

2. Permitting of the non-permitted structures on site

3. Removal of the remaining (selected) non-permitted structures on site

### Pitkin County Land Use

5-20-60 and 5-20-70.

4. The existing and proposed structure complies with site setbacks 5. The existing and proposed remodel complies with height requirements for the zone district

6. The residence is in conformance with Pitkin County Land use, using earth tone materials, minimal site clearing, and using existing disturbance patterns

7. The residence is in conformance with Pitkin County lighting ordinances and is dark sky compliant. The residence will comply with full dark sky compliant lighting and cut sheets for the exterior lighting is included with the application. There is minimal outdoor lighting planned at the garage and breezeway. The cylindrical lighting is all down lighting with a controlled beam spread, minimizing light pollution and observes LUC required full site cut-off.

8. The existing residence is constructed of Class A roofing materials (asphalt shingle). The proposed new roofs are rusty metal roofs (for added fire resistance) 9. We do not exceed the maximum floor area for the principal dwelling. The accessory structures are a greenhouse for agricultural purposes and a fuel storage shed. We have performed height and square footage calculations as per Pitkin County Land Use Code

10. Our residence and access are in conformance with the existing site plan. 11. We will maintain defensible space around the permitter of the residence in accordance with the Rural Fire Department guidelines, Firewise Construction (NFPA guidelines are strictly adhered to) and the recommendations of Pitkin County.

12. As part of our construction management plan we will maintain ABC fire extinguisher both on site during construction and at occupancy.

## Applicable Land Use Code, Pitkin County Planning

Our existing building meets the 2006 Pitkin County Land Use Code. Our addition will meet the updated building codes as adopted by Pitkin County Building Department. Our site plan maximizes open space, leaves in place the mature (state) trees, and maximizes undisturbed land on the parcel.

### 5-20-60 Measurement of Building Height

Our building height as calculated by (a) pitched roofs, is taken at the mid-point of the roof (halfway between the top the ridge and the eave-point. Our measurement vertically is from existing grade vertically. The existing residence building height measured from bottom of slab to mid-point of the roof is under 28' (Peak x Mid Point of the roof y.)

### 5-20-70 Measurement of Floor Area

Our square footage as calculated by Pitkin County 5-20-70 is less than allowed under the GMQS exemption

## **Current and Proposed Floor area of 41 Rainbow:**

BASEMENT AREA OPEN PORCH	720 49		1,379, TBC 491 (Both at Grade, stone)
WOOD BALCONY	240	552	(1st 8' Exempt, so 297' is exempt)
FIRST FLOOR	1,197	1,670	
SECOND FLOOR	<u>1,981</u>	2,242	
TOTAL HEATED SQ FT	3,178	3,912	as defined by 5-20-70: Measurement of Floor Area, as measured from the outside face o framing.
GARAGE BUILT INTO BASEMENT	720	517	Explanation: More interior/heated space) as per as per 5-20-70(2), Does not exceed 750'
BEDROOMS	3	4	
BATHS	4.5	5.5	Basement 1/2 Bath Powder Main 3 Bath + 1/2 Bath Powder

Upper 1 Bath + 1/2 Bath Powder

EXISTING PROPOSED

#### 156 SF 169 SF Metal Shed 13' x 13' 648 SF Shed 24' x 27'

Shed	8' x 12'	<u>96 SF</u>
		1,069 SF
Exempt Sheds (Ag	ricultural) and G	reenhouse (Food Production
Gas Storage Shed	10.5 x 13.5'	141.75 SF

## 403.50 SF So potential buildout, if no structures are removed

5' x 24'

10.5 x 13.5'

Existing sheds (largely in set-backs)

Adjoiner Wood Shed 12' x 13'

WOOD BALCONY TOTAL HEATED SQ FT	255 SF 3,912 4,167 SF
Existing Sheds Potential Exempt Sheds	1,069 503.50 SF

## Potential SF

Gas Pump Shed

Greenhouse

Floor Area Notes: (A) Our MEP room does not exceed 2% of the total floor area. The MEP room is 34 SF which is xx% of the floor area (excluding the garage)

141.75 SF

120.00 SF

5,739.50

(B) Our upper level deck overhangs exceed 8', so the decks were included in the square footage calculations, after our exempt 8'.

(C) Crawl spaces were not included in our square footage calculations. There are no crawl

(D) Attic spaces were not included in our square footage calculations.

(E) 5-20-70(2) Garages and Carports where the principal use is a single family residence we are exempted up to a maximum of seven hundred fifty (750) square feet.

cloud hill design, llc

Cloud Hill Design, LLC Snowmass CO 81654 USA

## INTEGRATED DESIGN TEAM

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Design Travis Terry Design, Terry I Mc Manamon Travis Terry

Structural Engineer Brian Rossitor, PE

Survey Peak Surveying Inc. Jason R. Neil, P.L.S

Planning and Design Cloud Hill Design, LLC Jeffrey Woodruff

## 041 Rainbow Lane

41 Rainbow Lane Woody Creek CO 81656 M/B Woody Creek

Jennifer and Joseph Mason

Account #

264308100010 Parcel ID R003195

Date: Issue: 11/18/2021 Planning Pre-Application 01/14/2022 Schematic/Pricing **Building Pre-Application** 01/18/2022

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SHEET TITLE

Planning Analysis

Cloud Hill Design, LLC Snowmass CO 81654 USA

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MODEL FILE:
Mason RL\_02062022.pln


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SHEET TITLE

Demo Basement

A111

SHEET 9

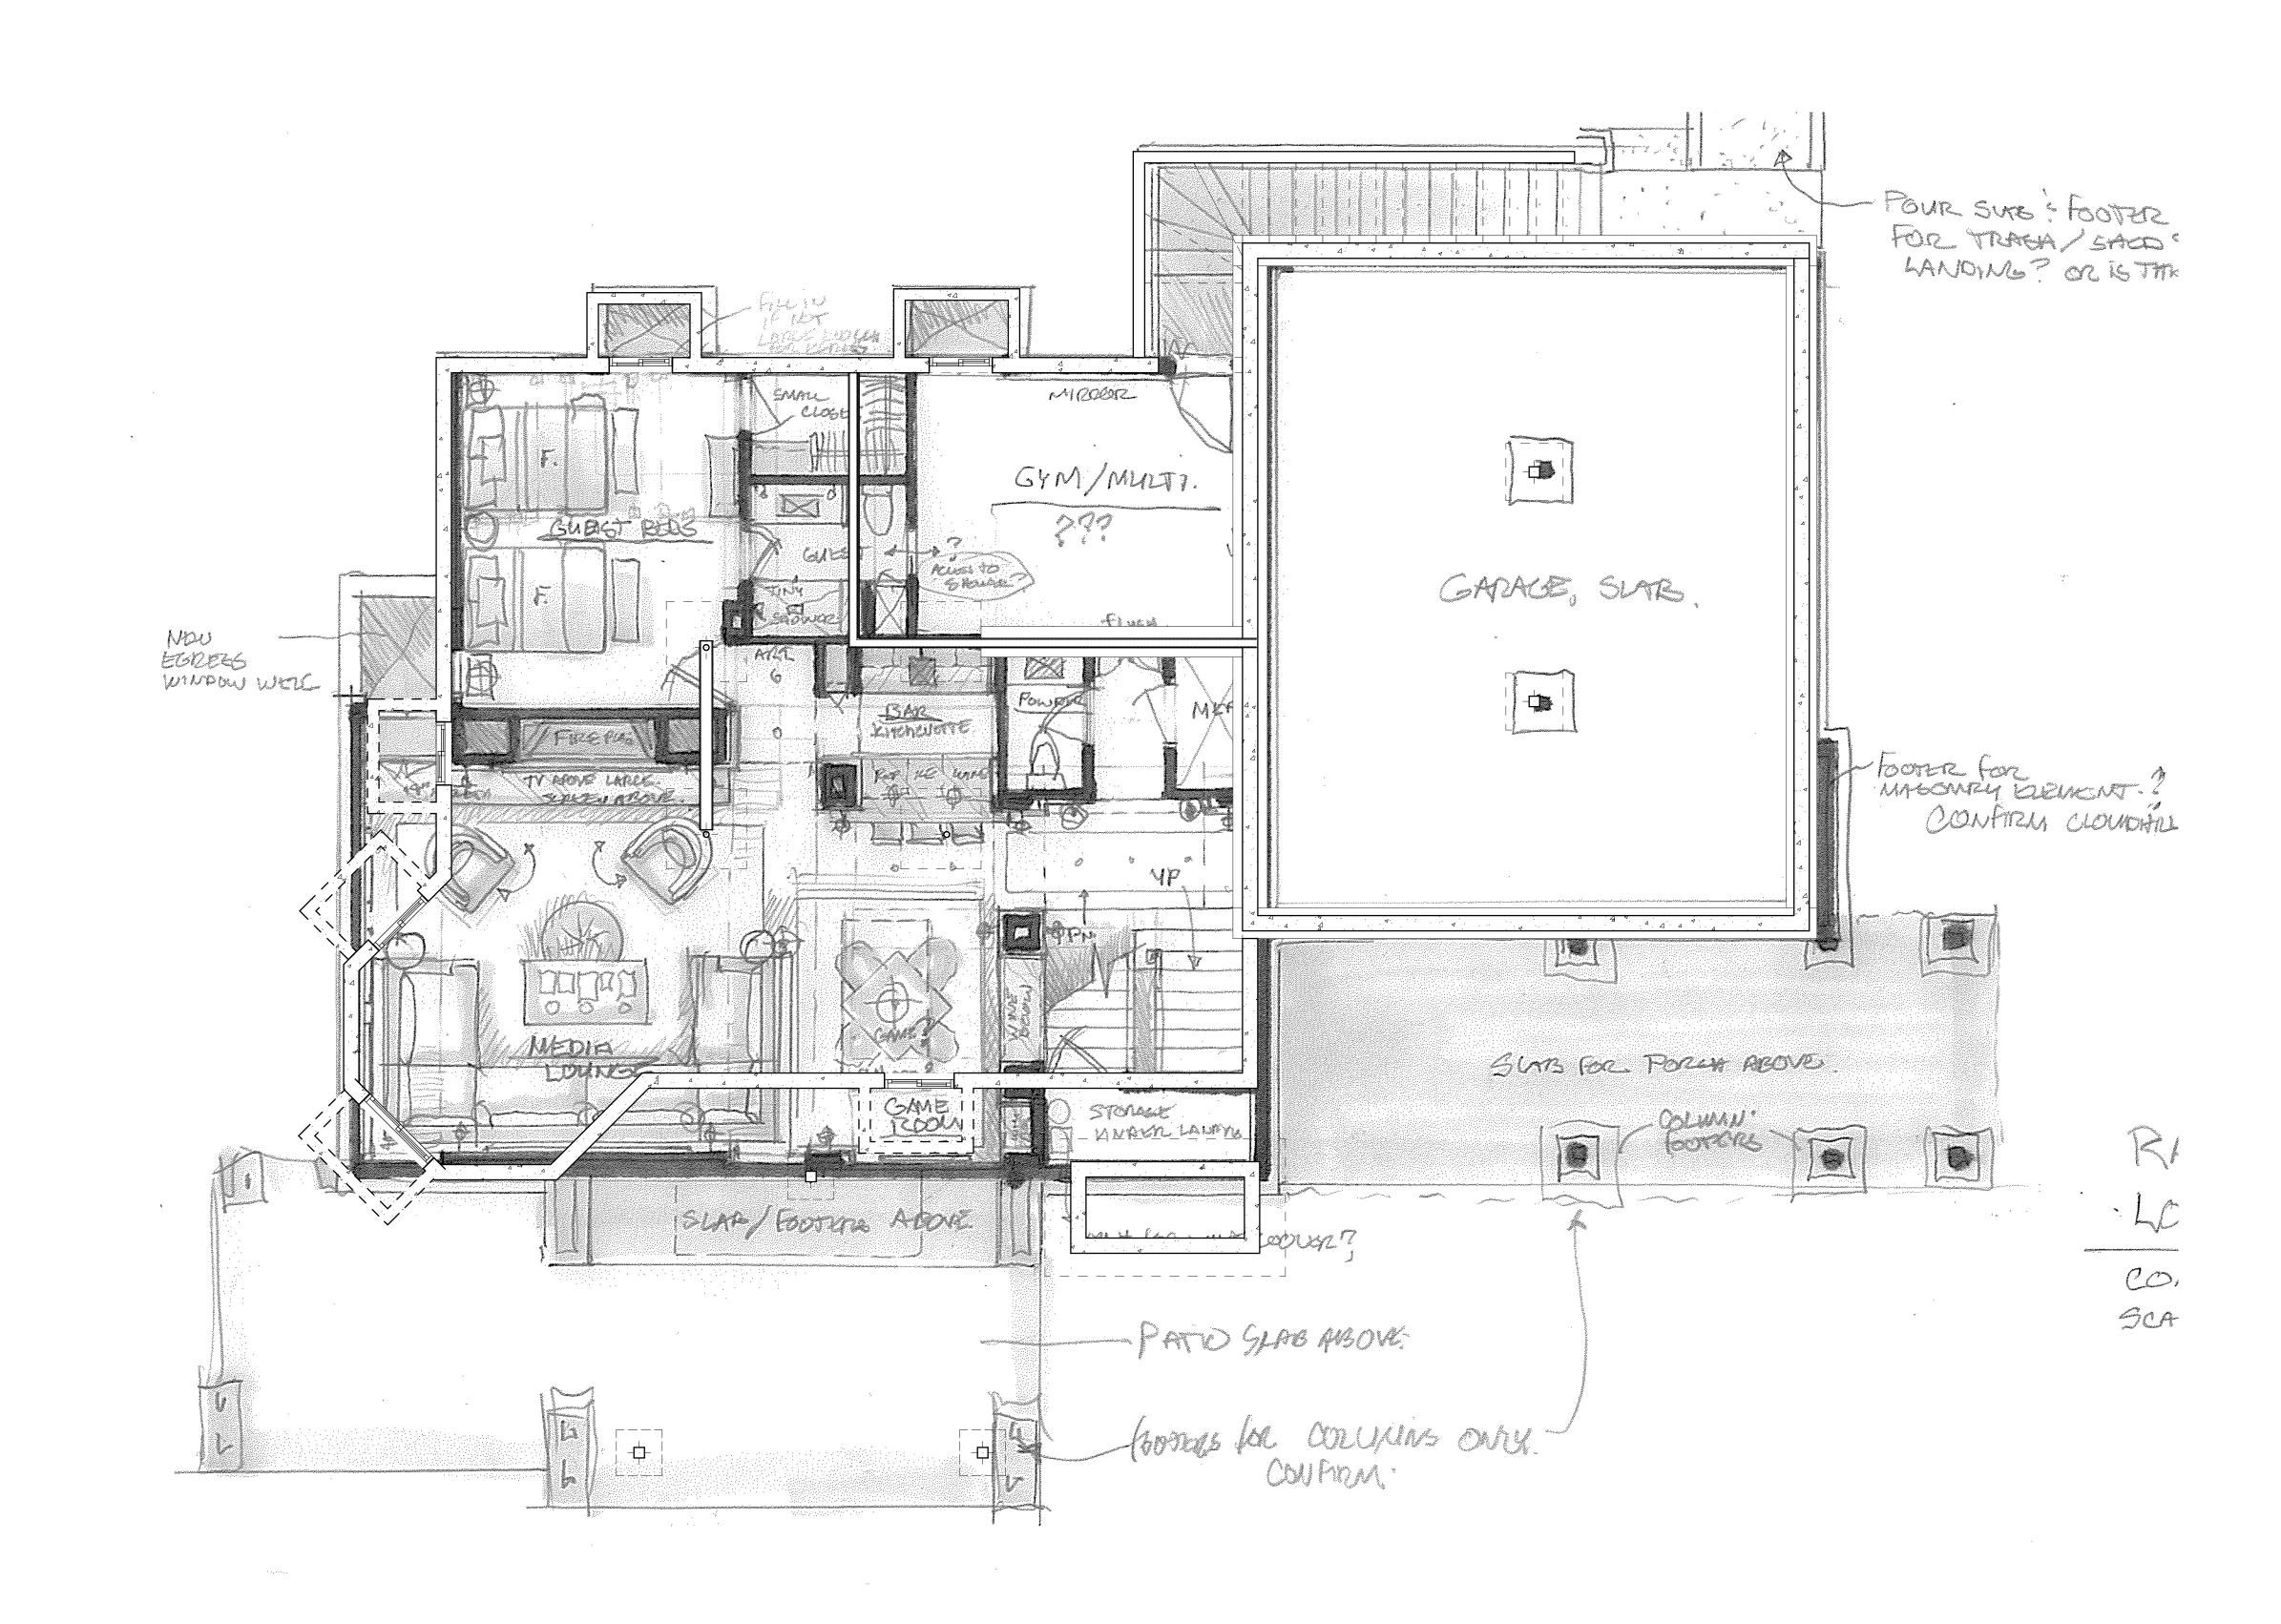

/w/Documents/Cloud Hill Design/0041 Rainbow Lane/Mason RL\_02062022.p

1 A111

Basement Demo

SCALE: 1/4" = 1'-0"

OLD DELK UMES.

Cloud Hill Design, LLC Snowmass CO 81654 USA

INTEGRATED DESIGN TEAM

General Contractor David Griesser

Design Travis Terry Design, Terry I Mc Manamon Travis Terry

Structural Engineer Brian Rossitor, PE

Survey Peak Surveying Inc. Jason R. Neil, P.L.S.

Planning and Design Cloud Hill Design, LLC Jeffrey Woodruff

041 Rainbow Lane

41 Rainbow Lane Woody Creek CO 81656 M/B Woody Creek

Jennifer and Joseph Mason

Parcel ID 264308100010 Account # R003195

Date: Issue: Planning Pre-Application 11/18/2021 01/14/2022 Schematic/Pricing

**Building Pre-Application** 

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Demo Main Level

A112

SHEET 10

Main/Mid Floor Demo SCALE: 1/4" = 1'-0"

Design Travis Terry Design, Terry I Mc Manamon Travis Terry

Structural Engineer Brian Rossitor, PE

Survey Peak Surveying Inc. Jason R. Neil, P.L.S.

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PROJECT NO: Project No. 210

MODEL FILE:
Mason RL\_02062022.pln


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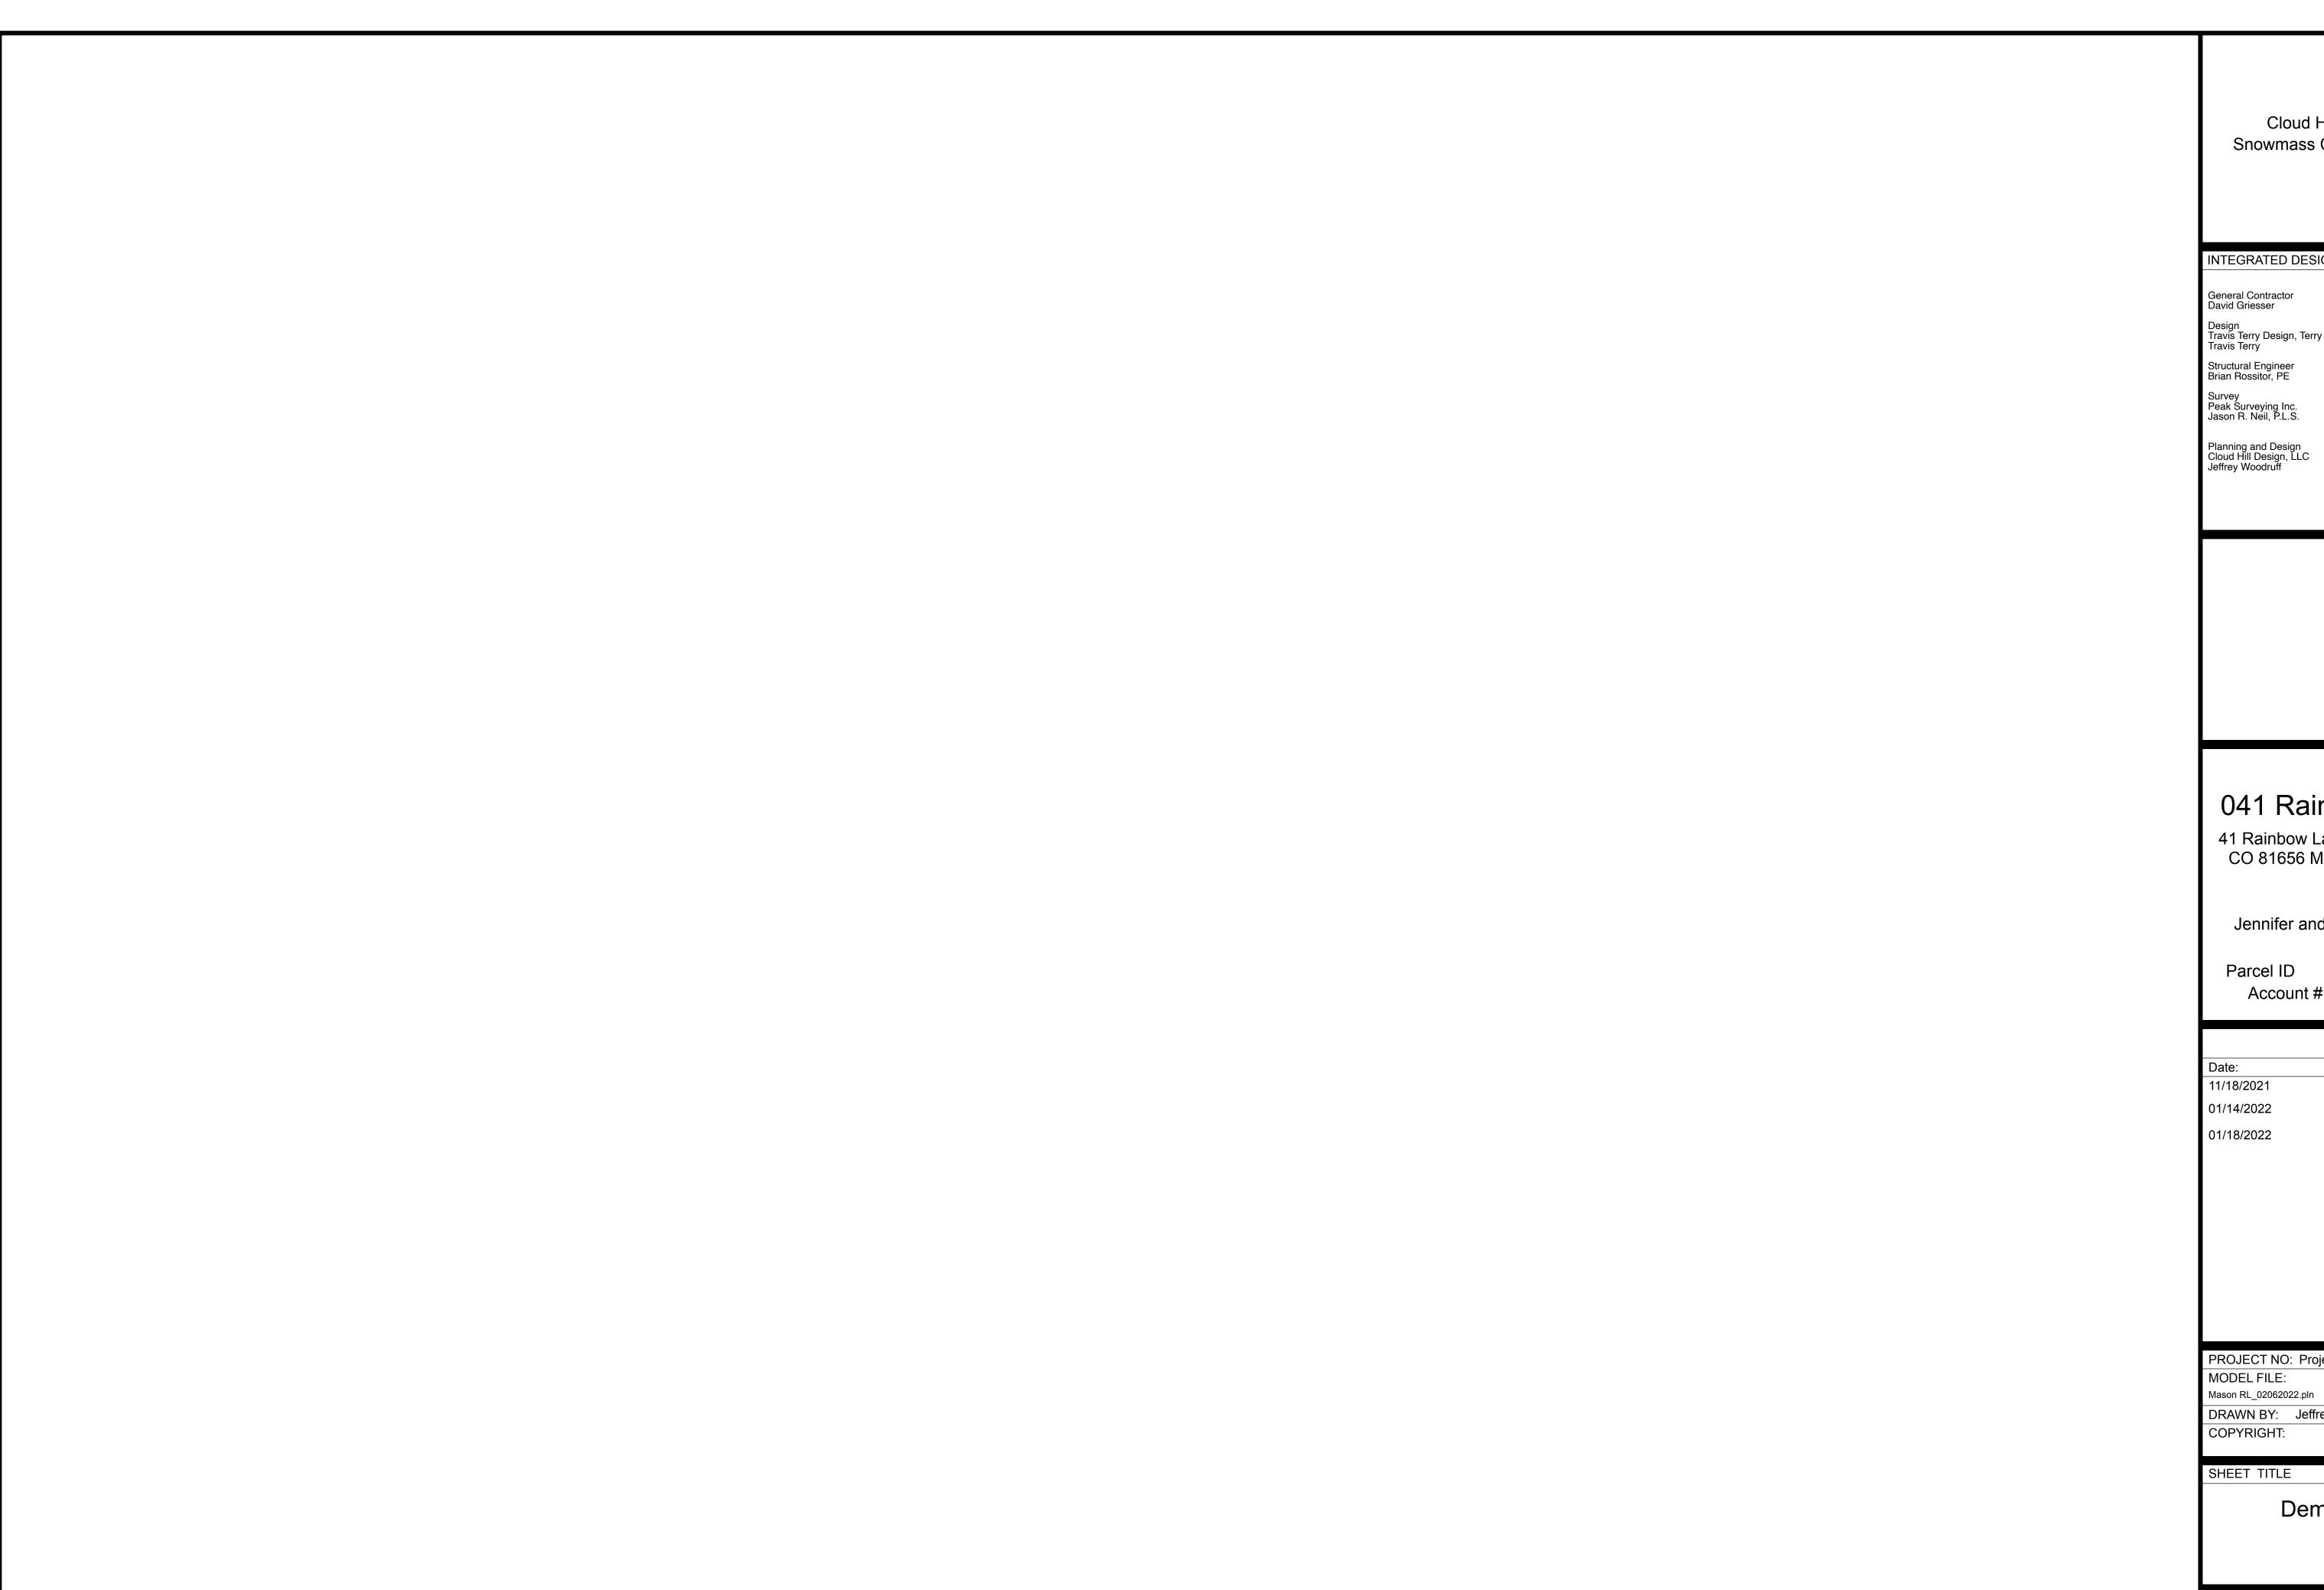
Demo Upper Level

A114

SHEET 11



Demo Upper Level Plan
SCALE: 1/4" = 1'-0"

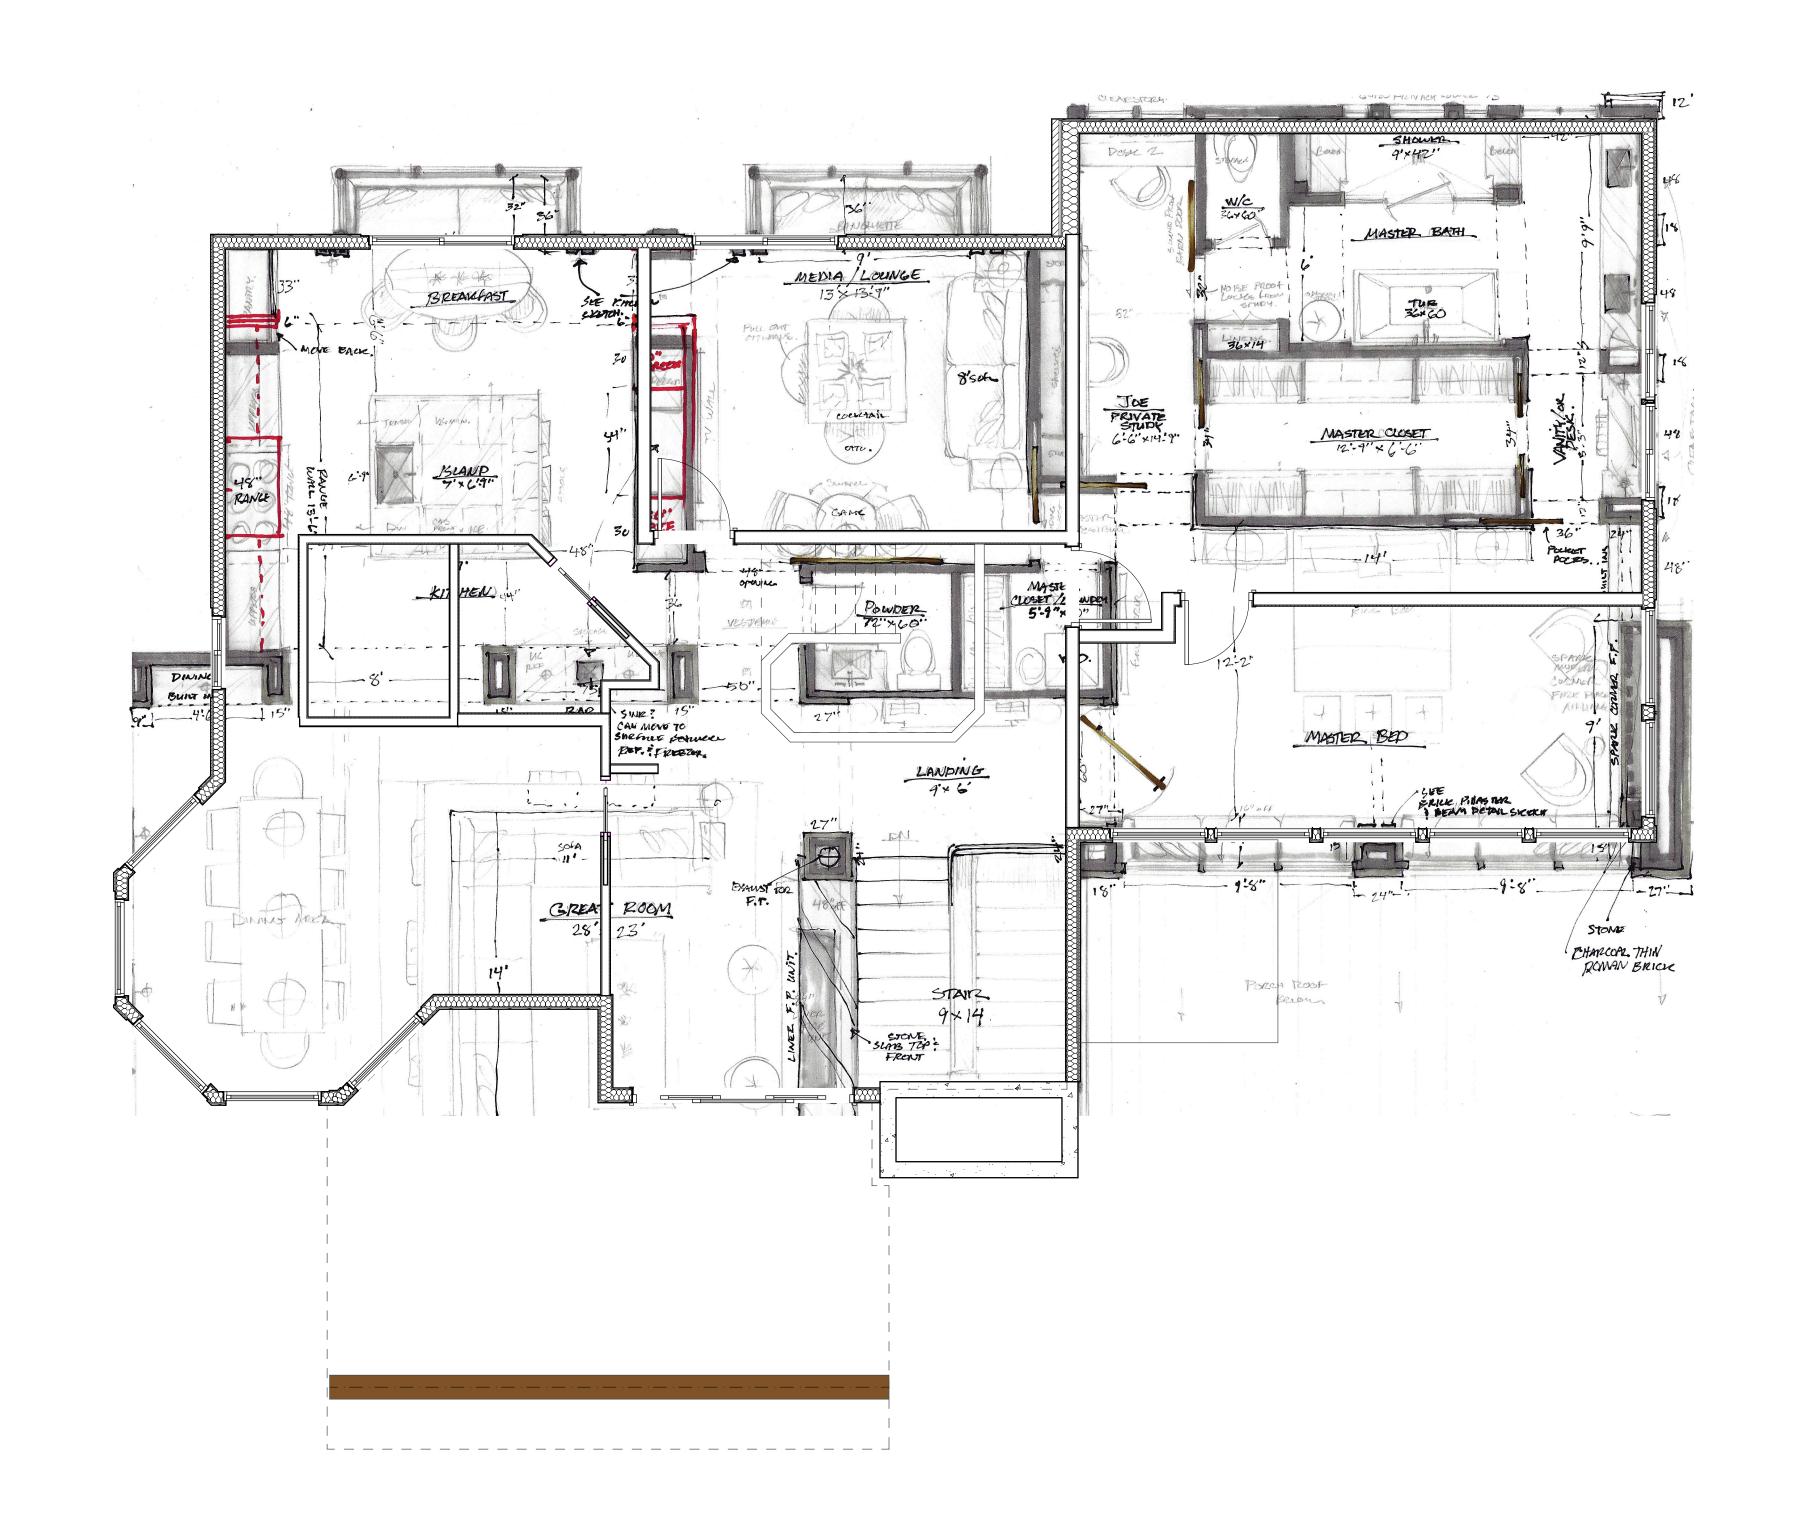

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INTEGRATED DESIGN TEAM

Design Travis Terry Design, Terry I Mc Manamon Travis Terry

041 Rainbow Lane

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Jennifer and Joseph Mason

Parcel ID

264308100010 Account # R003195

Issue: Planning Pre-Application 11/18/2021 01/14/2022 Schematic/Pricing **Building Pre-Application** 

PROJECT NO: Project No. 210

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Demo Roof

A115

Cloud Hill Design, LLC Snowmass CO 81654 USA

INTEGRATED DESIGN TEAM

General Contractor David Griesser

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**Proposed Basement** 

A120

SHEET 13

jeffreyw/Documents/Cloud Hill Design/0041 Rainbow Lane/Mason RL\_02062022.plr

**Basement Travis** 

SCALE: 1/4" = 1'-0"

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INTEGRATED DESIGN TEAM

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01/14/2022 Schematic/Pricing
01/18/2022 Building Pre-Application

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SHEET TITLE

Proposed Main Level

A121

SHEET 14

rs/jeffreyw/Documents/Cloud Hill Design/0041 Rainbow Lane/Mason RL\_02062022.plr

Main/Mid Floor Travis

SCALE: 1/4" = 1'-0"

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01/14/2022 Schematic/Pricing
01/18/2022 Building Pre-Application

PROJECT NO: Project No. 210

MODEL FILE: Mason RL\_02062022.pln

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SHEET TITLE

Proposed Upper Level

A122

SHEET 15

freyw/Documents/Cloud Hill Design/0041 Rainbow Lane/Mason RL\_0206203

1 Upper Level Plan Travis
A122 SCALE: 1/4" = 1'-0"

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INTEGRATED DESIGN TEAM

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264308100010 Parcel ID Account # R003195

Issue: Planning Pre-Application 11/18/2021 01/14/2022 Schematic/Pricing **Building Pre-Application** 01/18/2022

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SHEET TITLE

Propsosed Roof

A123

SHEET 16

1 Roof travis
A123 SCALE: 1/4" = 1'-0"

North East Elevation
SCALE: 1/4" = 1'-0"



South East Elevation Existing
SCALE: 1/4" = 1'-0"

cloud hill design, llc

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01/18/2022 Building Pre-Application

PROJECT NO: Project No. 210

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Elevations Existing

A200





SCALE: 1/4" = 1'-0"

SCALE: 1/4" = 1'-0"

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264308100010 Parcel ID Account # R003195

Date: Issue: Planning Pre-Application 11/18/2021 01/14/2022 Schematic/Pricing 01/18/2022 **Building Pre-Application** 

PROJECT NO: Project No. 210 MODEL FILE: Mason RL\_02062022.pln

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SHEET TITLE

Elevations Existing

A201

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INTEGRATED DESIGN TEAM

General Contractor David Griesser

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Structural Engineer Brian Rossitor, PE

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Planning and Design Cloud Hill Design, LLC Jeffrey Woodruff

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041 Rainbow Lane

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Date: Issue:
11/18/2021 Planning Pre-Application
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**Building Pre-Application** 

PROJECT NO: Project No. 210

MODEL FILE: Mason RL\_02062022.pln


01/18/2022


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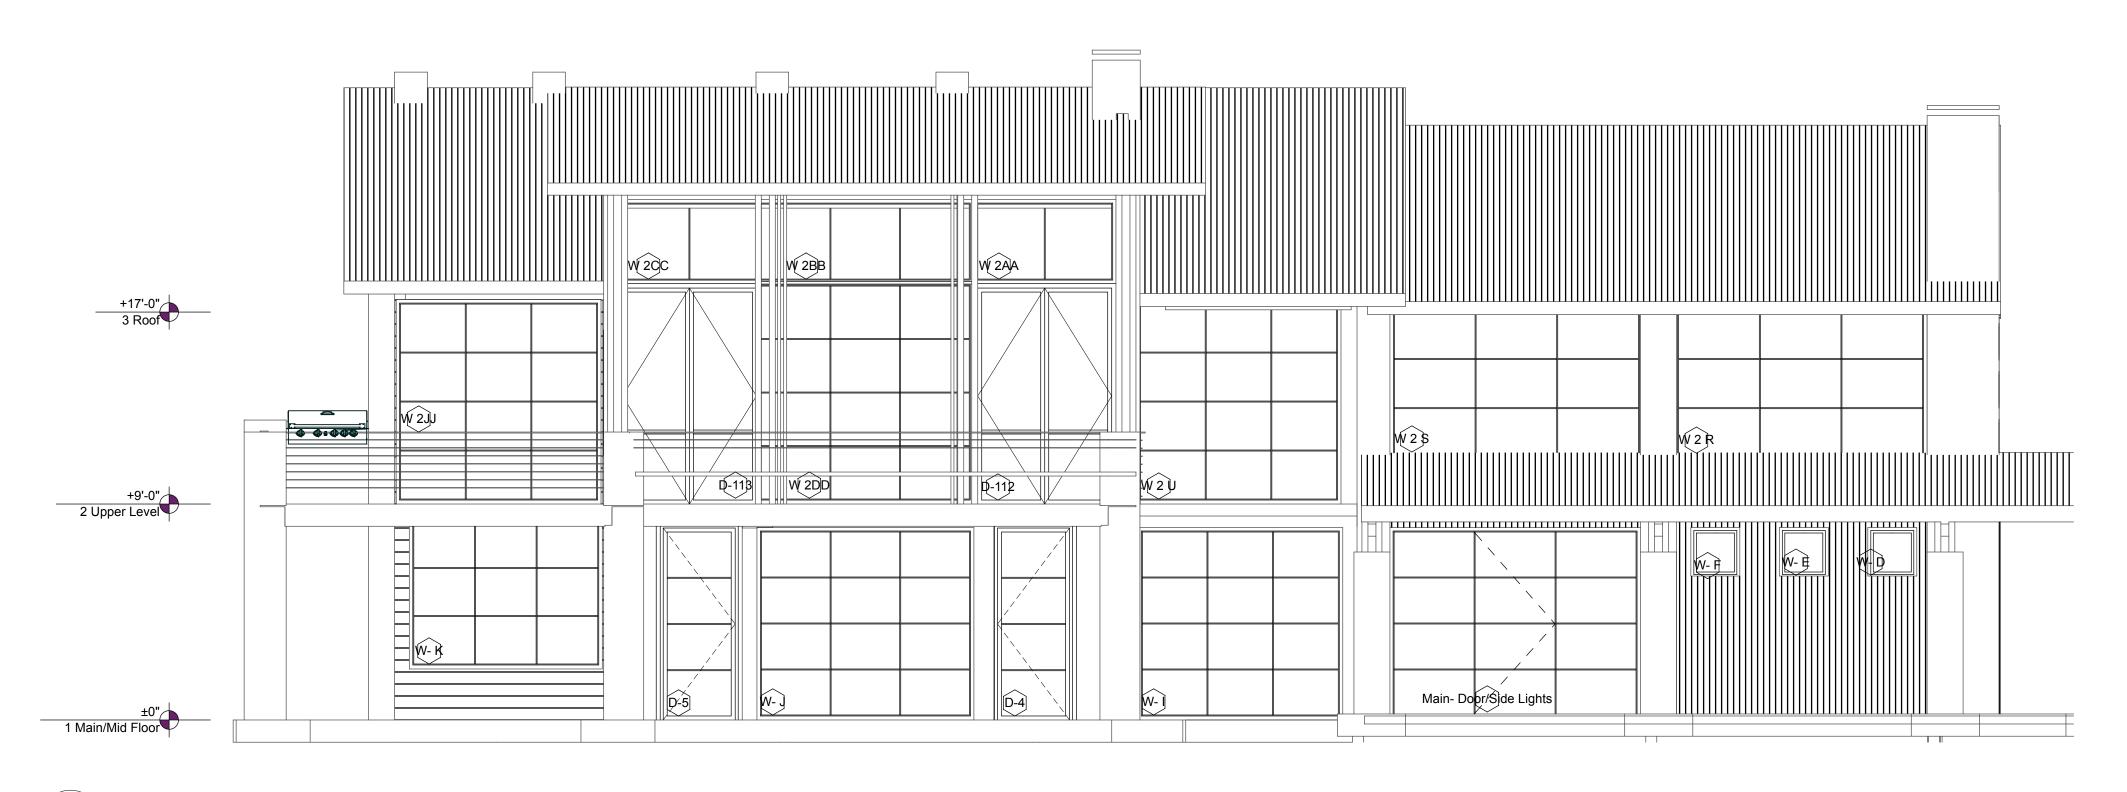
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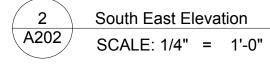
**Elevations New** 

A202





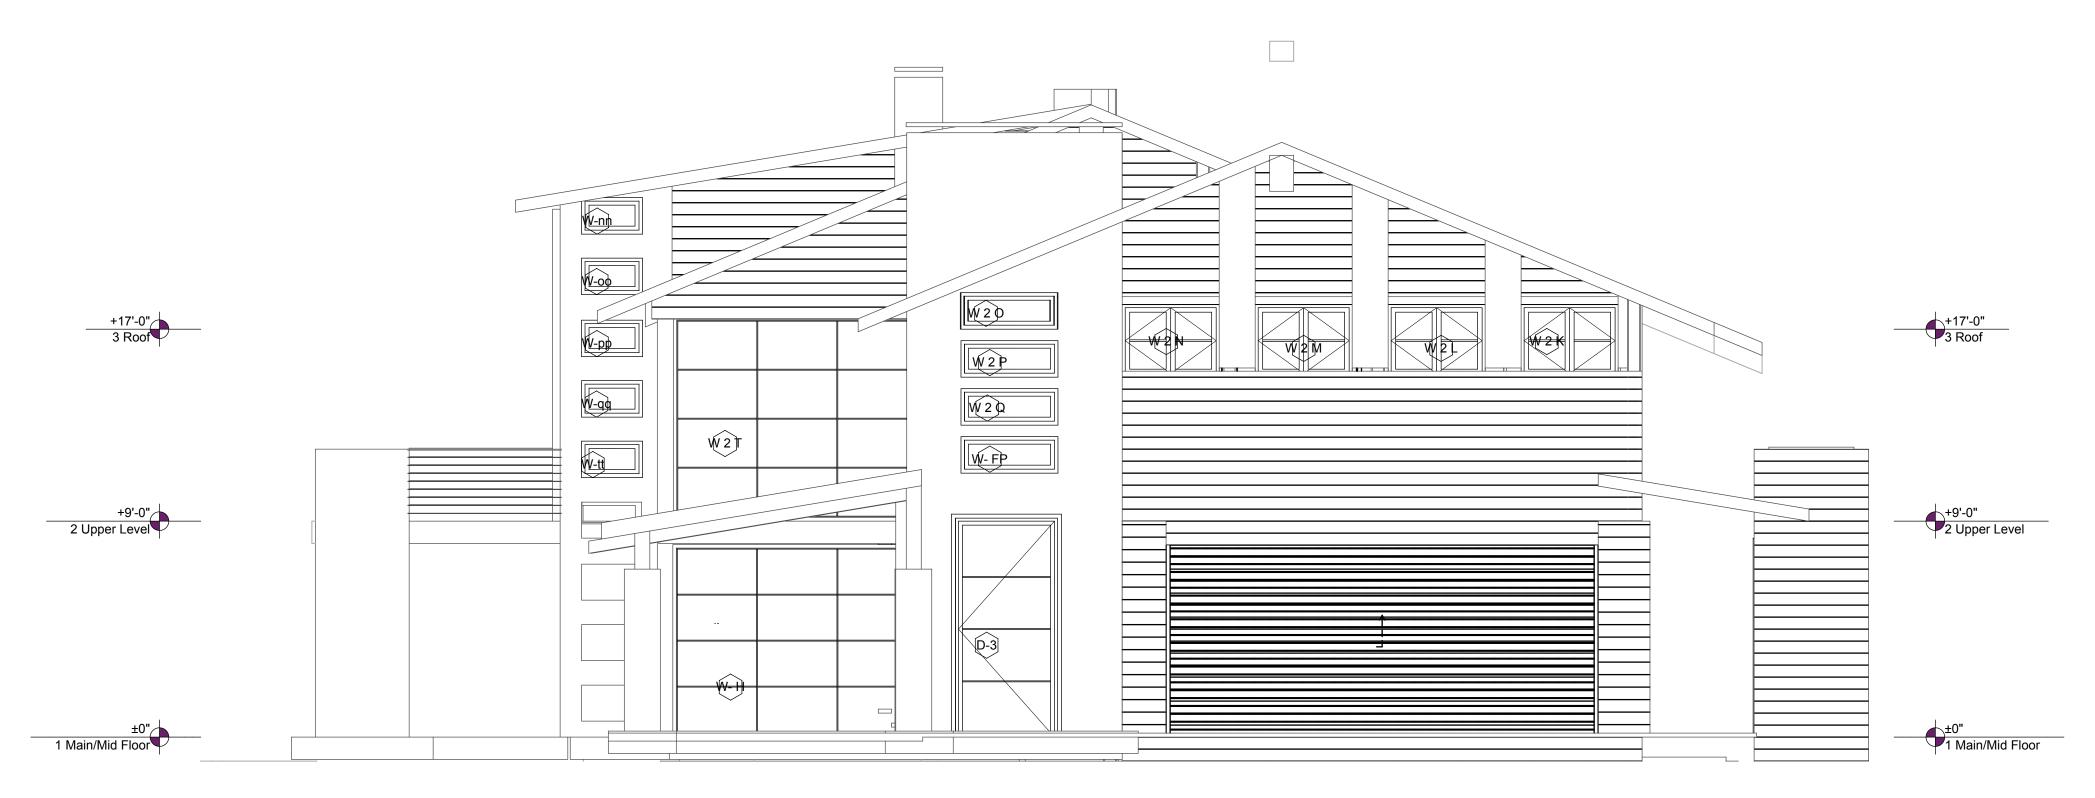

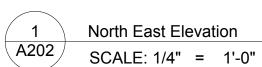



Cloud Hill Design, LLC Snowmass CO 81654 USA

## INTEGRATED DESIGN TEAM

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264308100010 Parcel ID Account # R003195

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**Building Pre-Application** 

PROJECT NO: Project No. 210

MODEL FILE: Mason RL\_02062022.pln

01/18/2022


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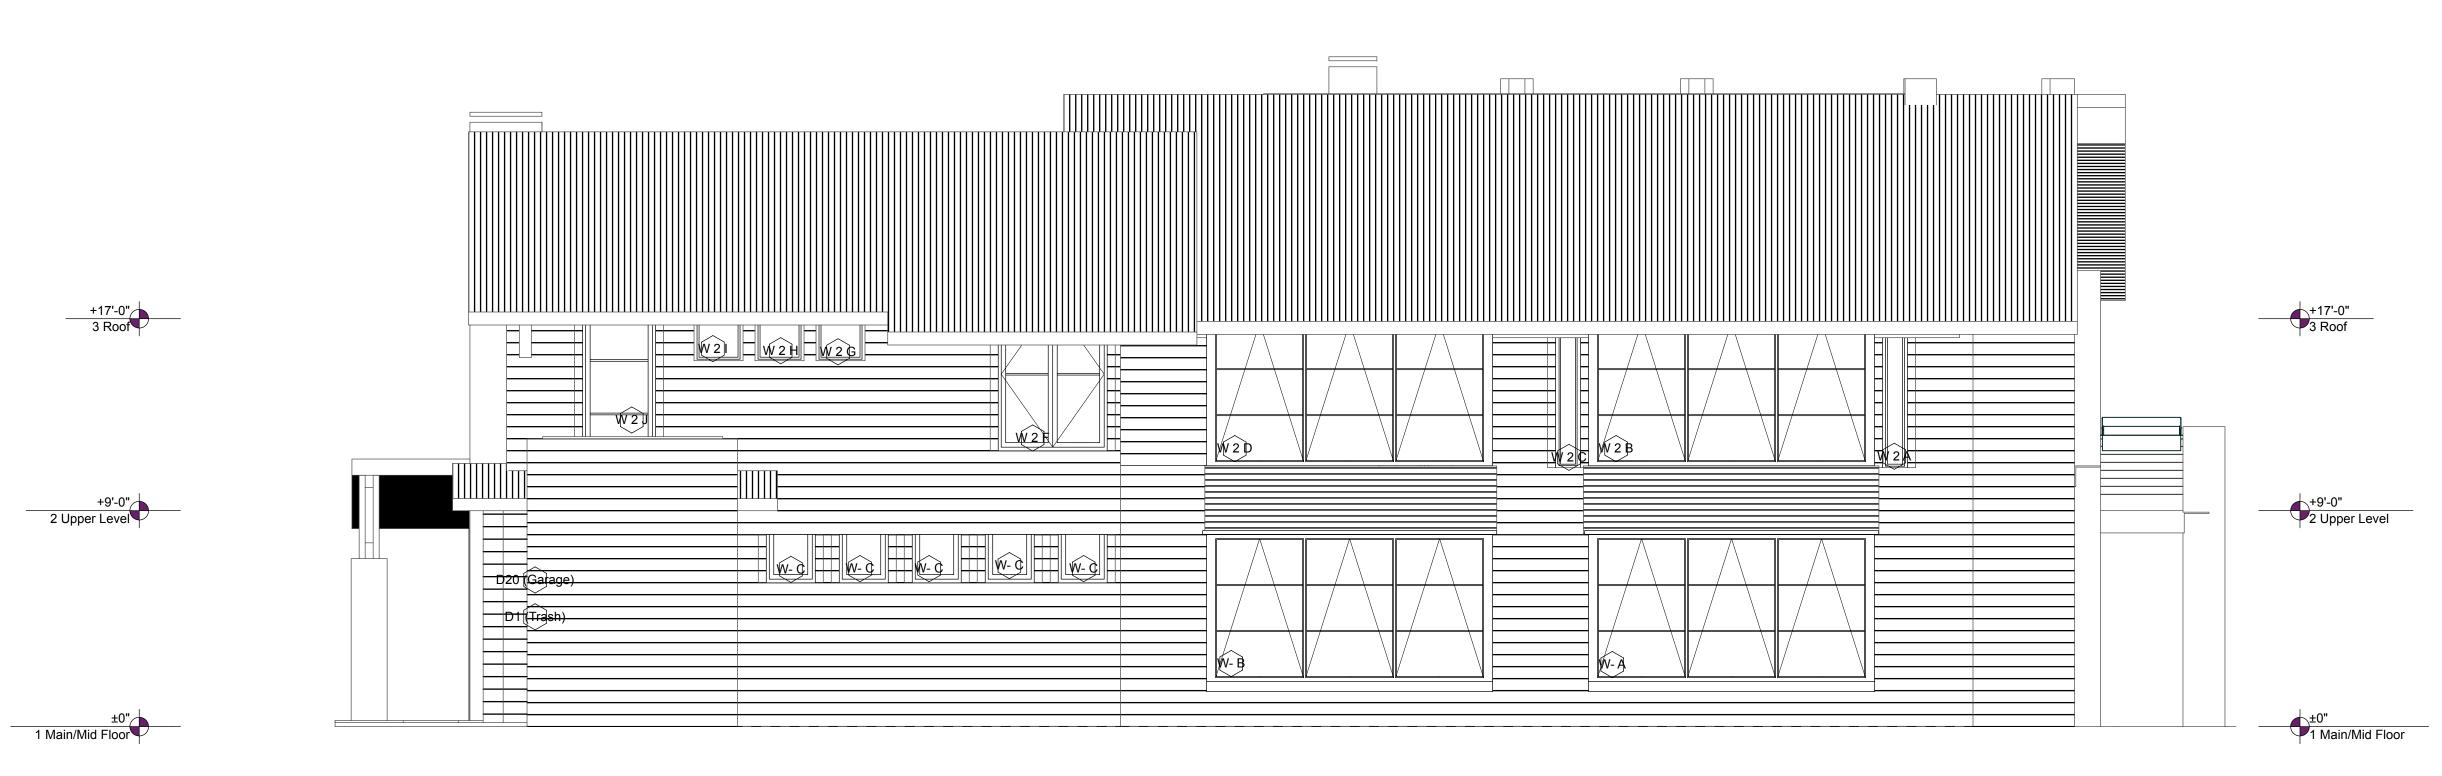
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**Elevations New** 


A203

SHEET 20




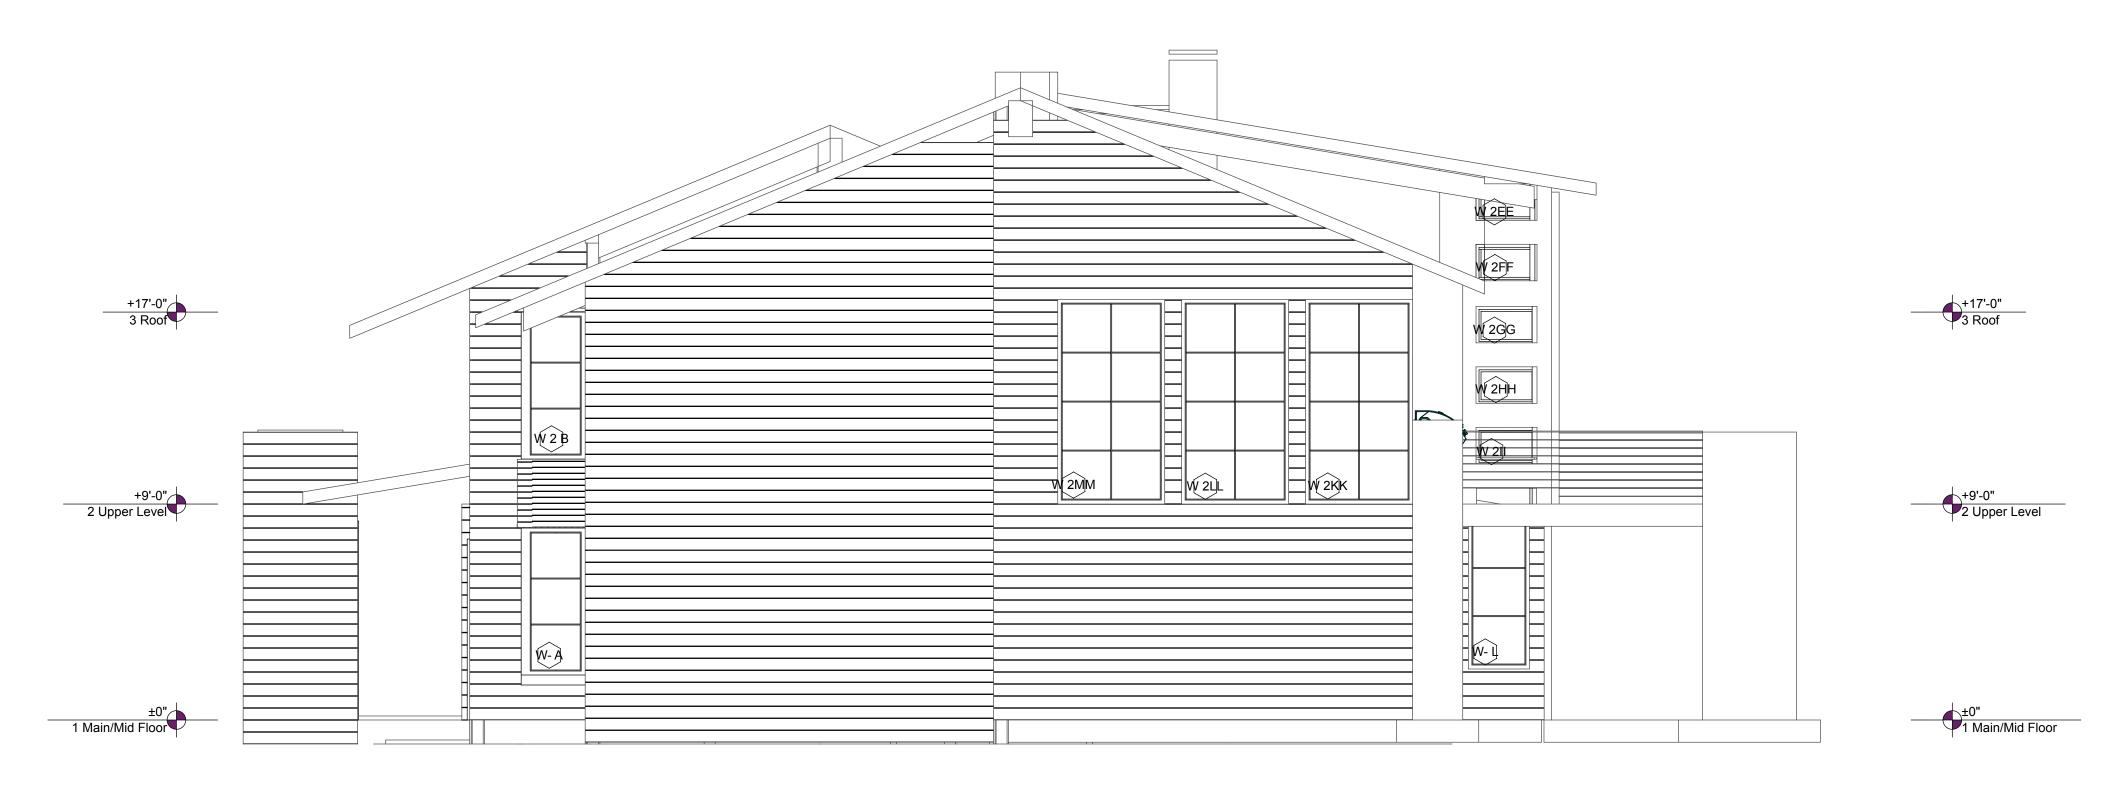

North West Elevation SCALE: 1/4" = 1'-0" South West Elevation SCALE: 1/4" = 1'-0"

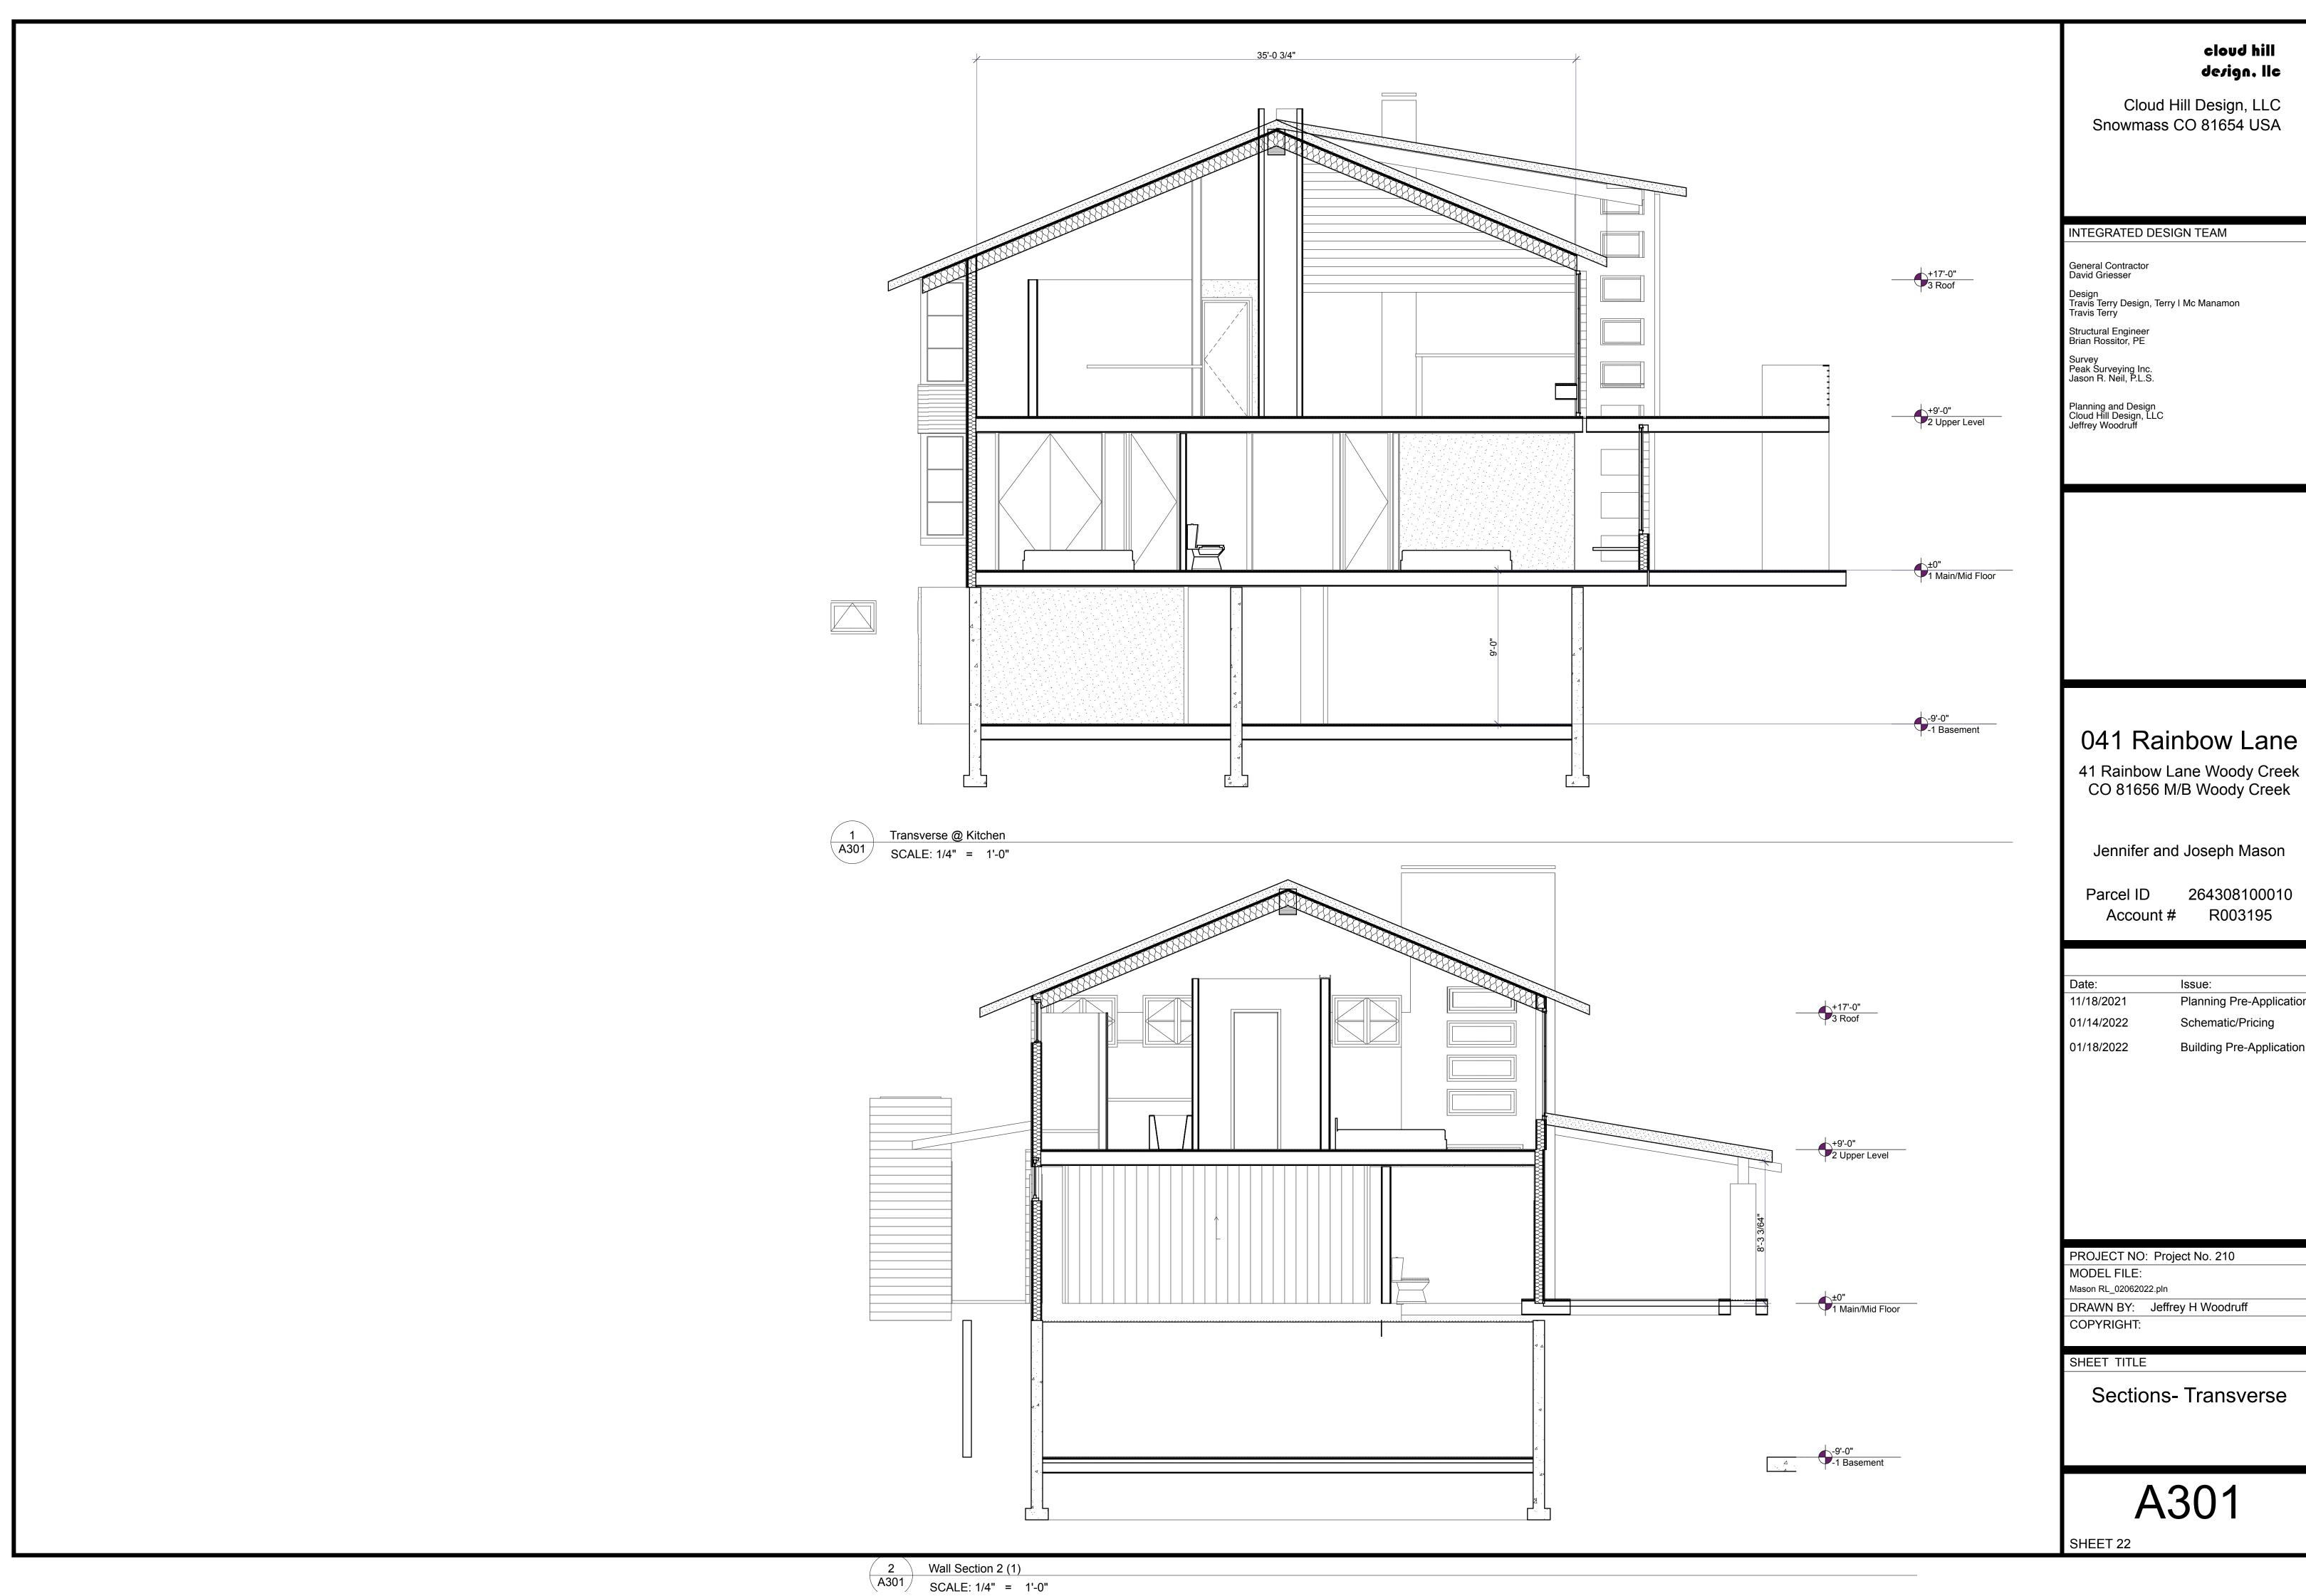

Planning Pre-Application **Building Pre-Application** 

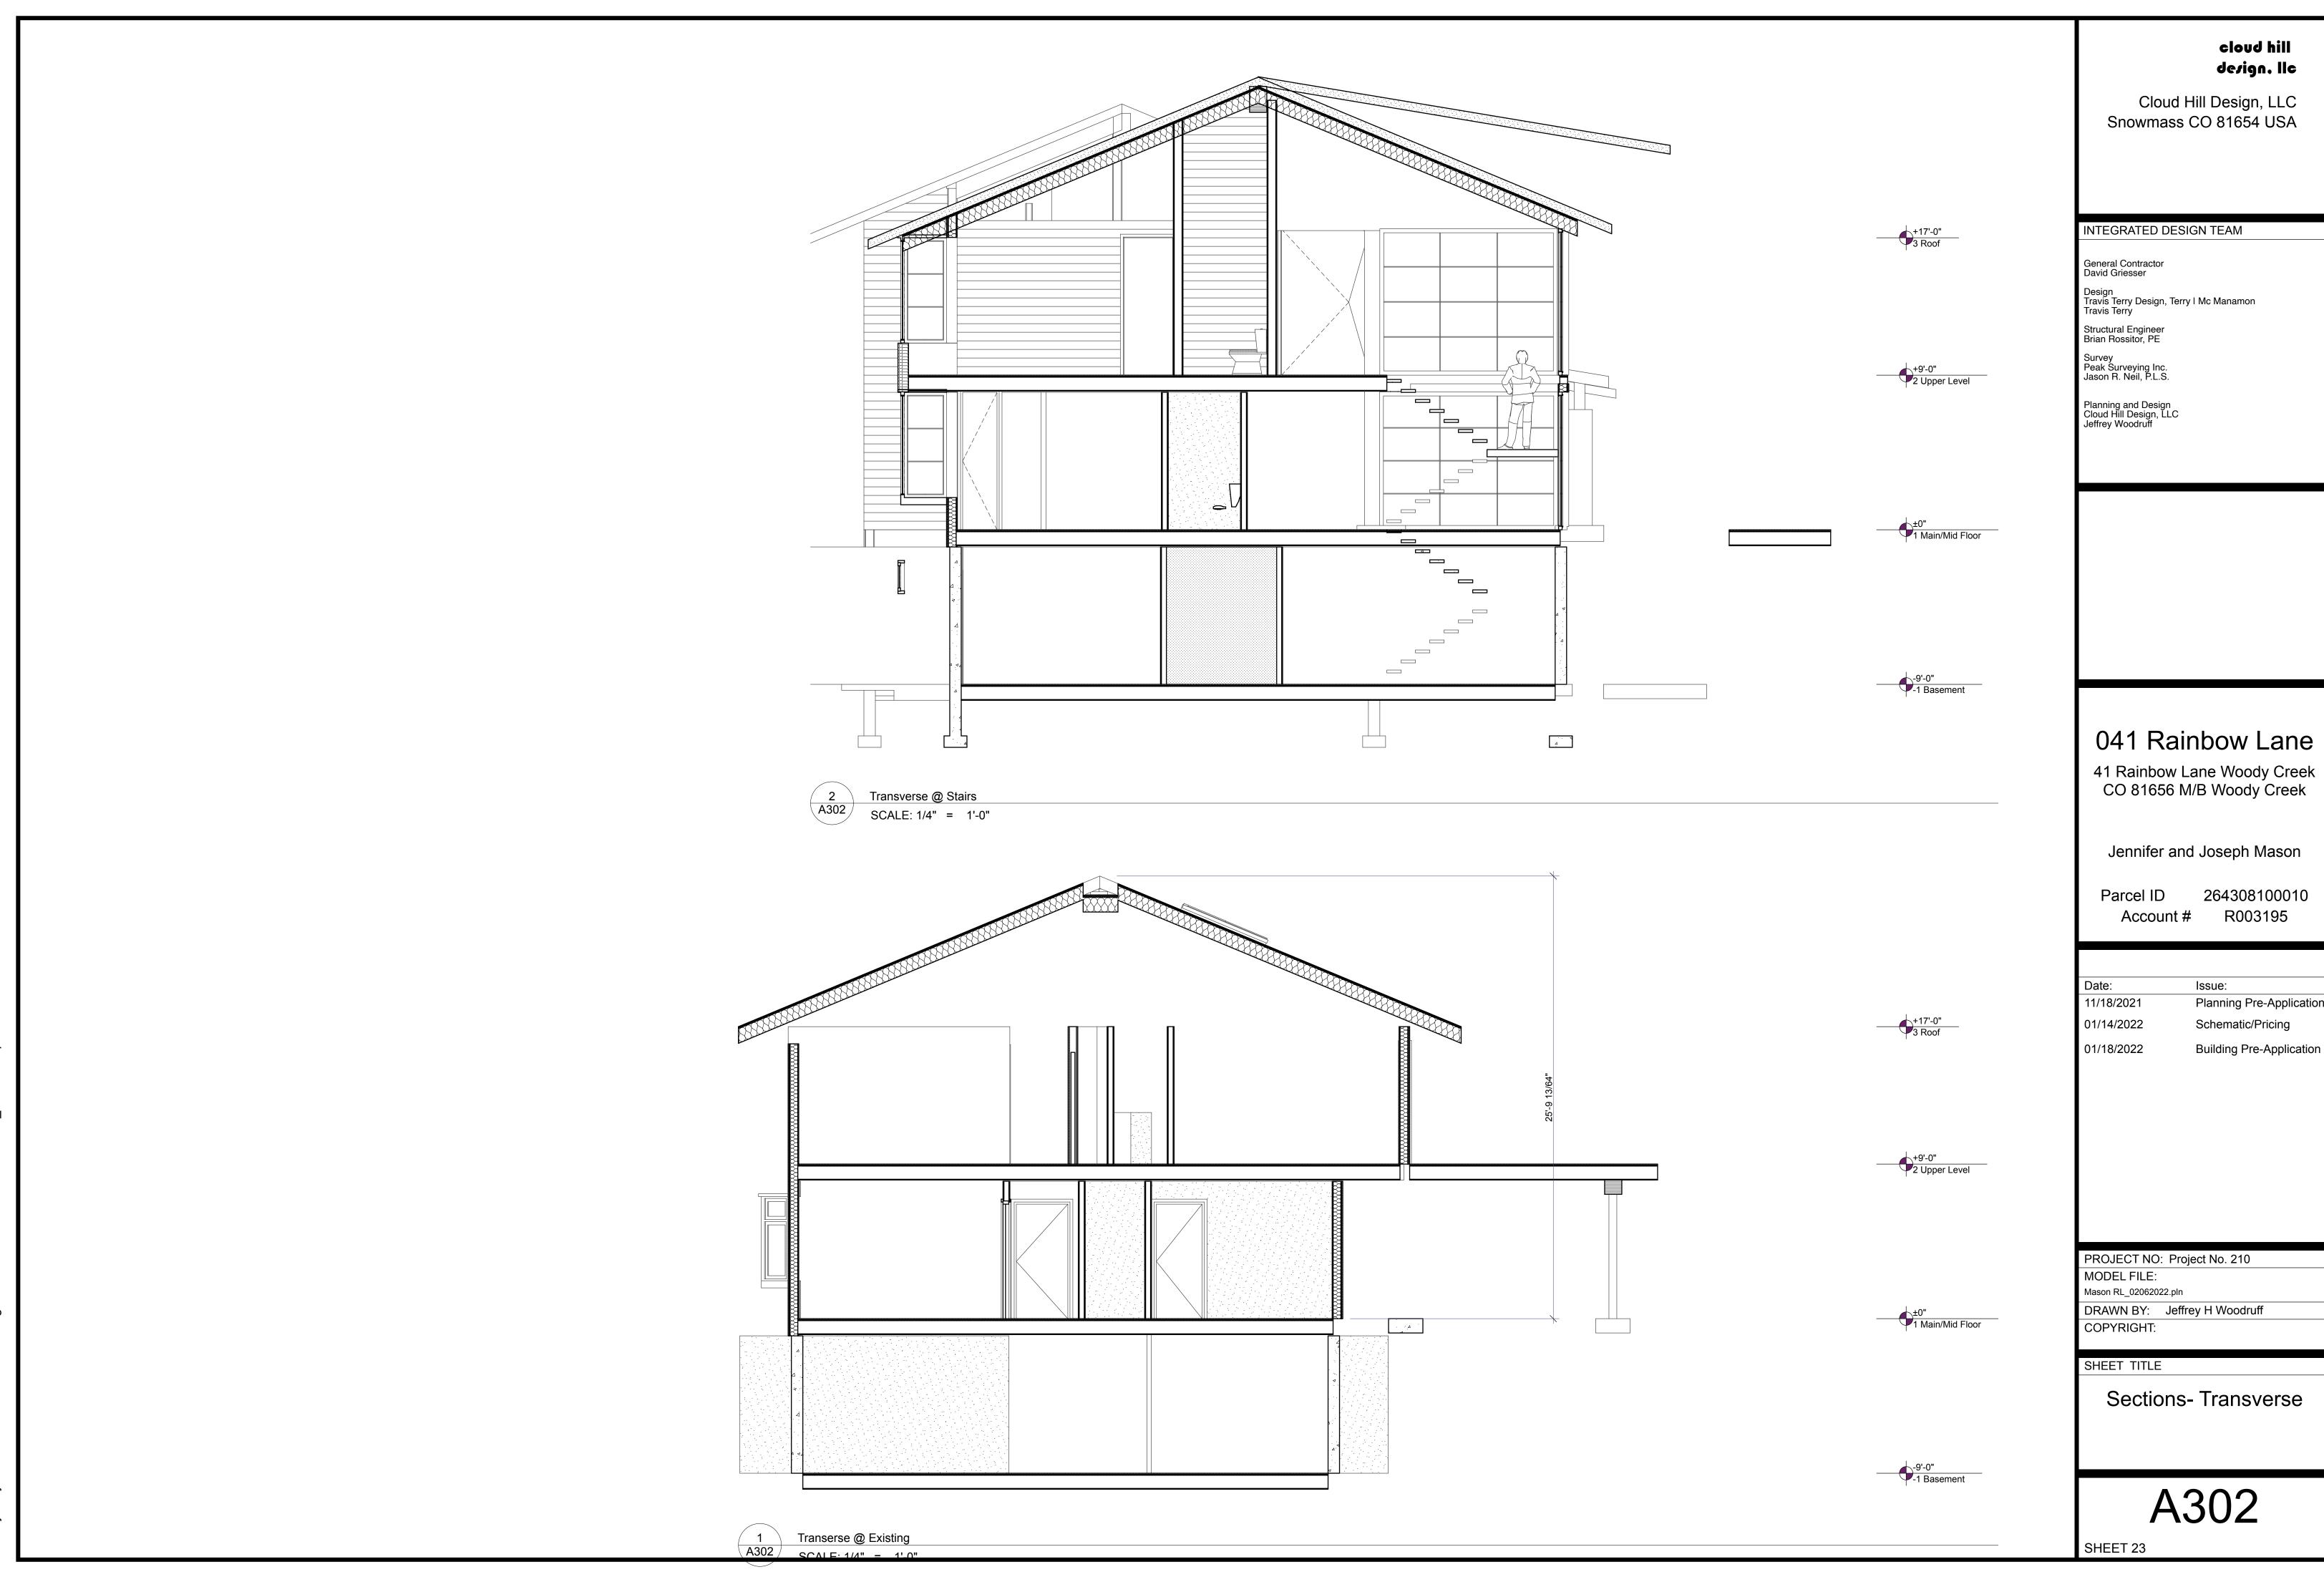

Planning Pre-Application **Building Pre-Application** 

Window Legend SCALE: 1' = 1'-0"

W	/INDOW NUMBER		WIDO	N SIZE	WINDOW SCHEDULE	
ООМ	ID	ROOM NAME	NOMINAL WIDTH	NOMINAL HEIGHT	Window Type Details  HEAD  DETAIL  JAMB DETAIL SILL DETAIL ACCESORIES STC	U-VALUE
	Main- Door/Side Lights		10'-5"	8'-0"	Door with sidelights/transom	IECC 2018
-	Opening		2'-6"	1'-6"	Awning	IECC 2018
-	W 2 A		1'-0"	6'-1 1/2"	Awning or fixed	IECC 2018
-	W 2 B		11'-6"	6'-1 1/2"	Fixed with awnings	IECC 2018
-	W 2 C		1'-0"	6'-1 1/2"	Awning	IECC 2018
-	W 2 D		11'-6"	6'-1 1/2"	Fixed with awnings	IECC 2018
-	W 2 F		4'-6"	6'-4"	Casement	IECC 2018
-	W 2 G		2'-0"	2'-6"	Awning	IECC 2018
-	W 2 H		2'-0"	2'-6"	Awning	IECC 2018
-	W 2 I		2'-0"	2'-6"	Awning	IECC 2018
-	W 2 J		3'-0"	7'-3"	Fixed	IECC 2018
-	W 2 K		4'-0"	3'-0"	Awning or Casement	IECC 2018
-	W 2 L		4'-0"	3'-0"	Awning or Casement	IECC 2018
-	W 2 M		4'-0"	3'-0"	Awning or Casement	IECC 2018
-	W 2 N		4'-0"	3'-0"	Awning or Casement	IECC 2018
-	W 2 O		4'-0"	1'-6"	Fixed	IECC 2018
-	W 2 P		4'-0"	1'-6"	Fixed	IECC 2018
-	W 2 Q		4'-0"	1'-6"	Fixed	IECC 2018
-	W 2 R		10'-6"	6'-6"	Fixed with casement, egress	IECC 2018
-	W2S		10'-6"	6'-6"	Fixed with casement, egress	IECC 2018
-	W 2 T		10'-3 1/2"	8'-6"	Fixed Fixed	IECC 2018
-	W 2 U		8'-6"	8'-6"	Fixed or awning	IECC 2018
-	W 2AA		5'-11"	3'-6"	Transom	IECC 2018
-	W 2BB		9'-0"	3'-6"	Transom	IECC 2018
-	W 2CC		5'-11"	3'-6"	Transom	IECC 2018
-	W 2DD		9'-0"	9'-3"	Fixed	IECC 2018
-	W 2EE		2'-6"	1'-6"	Fixed or awning	IECC 2018
-	W 2FF		2'-6"	1'-6"	Fixed or awning  Fixed or awning	IECC 2018
-	W 2GG		2'-6"	1'-6"	Fixed or awning  Fixed or awning	IECC 2018
-	W 2HH		2'-6"	1'-6"	Fixed or awning  Fixed or awning	IECC 2018
-	W 2II		2'-6"	1'-6"	Fixed or awning  Fixed or awning	IECC 2018
-	W 2JJ		8'-6"	8'-6"	Fixed	IECC 2018
-	W 2KK		4'-5"	8'-6"	Awning	IECC 2018
-	W 2LL		4'-5"	8'-6"	Awning	IECC 2018
-	W 2MM		4'-5"	8'-6"	Awning	IECC 2018
-	W- A		11'-6"	6'-1 1/2"	Bay with Egress	IECC 2018
-	W- B		11'-6"	6'-1 1/2"	Bay with Egress	IECC 2018
-	W- C		2'-0"	2'-6"	Awning	IECC 2018
-	W- C		2'-0"	2'-6"	Awning	IECC 2018
-	W- C		2'-0"	2'-6"	Awning	IECC 2018
-	W- C		2'-0"	2'-6"	Awning	IECC 2018
-	W- C		2'-0"	2'-6"	Awning	IECC 2018
-	W- D		2'-0"	2'-0"	Awning	IECC 2018
-	W- E		2'-0"	2'-0"	Awning Awning	IECC 2018
-	W- F		2'-0"	2'-0"	Awning Awning	IECC 2018
-	W- FP		4'-0"	1'-6"	Awning Awning	IECC 2018
-	W- H		10'-4"	8'-0"	Fixed	IECC 2018
-	W- I		8'-6"	8'-0"	Fixed	IECC 2018
-	W- J		9'-0"	8'-0"	Fixed with Awnings	IECC 2018
-	W- K		8'-0"	6'-4 1/2"	Fixed with Casement	IECC 2018
_	W- L		2'-6"	6'-4 1/2"	Casement, egress	IECC 2018
-	W-nn		2'-6"	1'-6"	Awning	IECC 2018
-	W-00		2'-6"	1'-6"	Awning Awning	IECC 2018
-	W-pp		2'-6"	1'-6"	Awning Awning	IECC 2018
_	W-qq		2'-6"	1'-6"	Awning Awning	IECC 2018
			/ -()	ı <b>-</b> O	AWHING	

Window Schedule

SCALE: 1' = 1'-0"

EGRESS- Required from Casement at lower level

cloud hill design, llc

Cloud Hill Design, LLC Snowmass CO 81654 USA

INTEGRATED DESIGN TEAM

General Contractor David Griesser

Design Travis Terry Design, Terry I Mc Manamon Travis Terry

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041 Rainbow Lane

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Parcel ID 264308100010 Account # R003195


Date: Issue: Planning Pre-Application 11/18/2021 Schematic/Pricing 01/14/2022 **Building Pre-Application** 01/18/2022

PROJECT NO: Project No. 210 MODEL FILE: Mason RL\_02062022.pln

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SHEET TITLE

Schedules



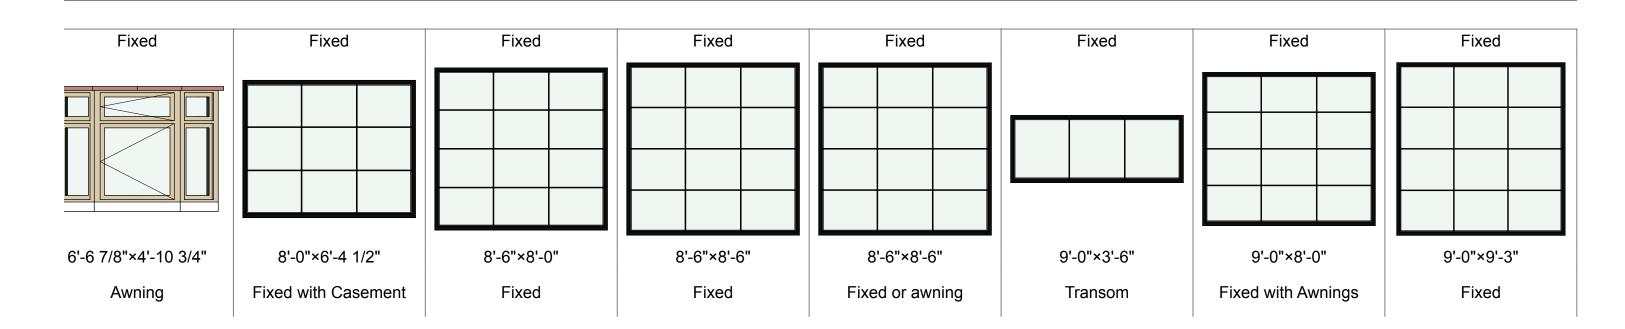


Window Legend SCALE: 1' = 1'-0"

**WINDOW LEGEND** 

Fixed	Fixed	Fixed	Fixed	Fixed	Fixed	Fixed	Fixed	Fixed	Fixed	Fixed	Fixed	Fixed	Fixed
2'-8 5/8"×1'-11"	3'-0 1/2"×3'-6 1/2"	3'-0 1/2"×4'-0 1/2"	3'-0"×3'-11 5/8"	3'-0"×7'-3"	3'-11"×3'-11 5/8"	4'-0 1/2"×4'-0 1/2"	4'-0"×1'-6"	4'-0"×1'-6"	4'-0"×3'-0"	4'-5"×8'-6"	4'-6"×6'-4"	5'-11"×3'-6"	6'-0 1/2"×4'-0 1/2"
Awning	Awning	Awning	Awning	Fixed	Awning	Awning	Awning	Fixed	Awning or Casement	Awning	Casement	Transom	Awning



Window Legend SCALE: 1' = 1'-0"

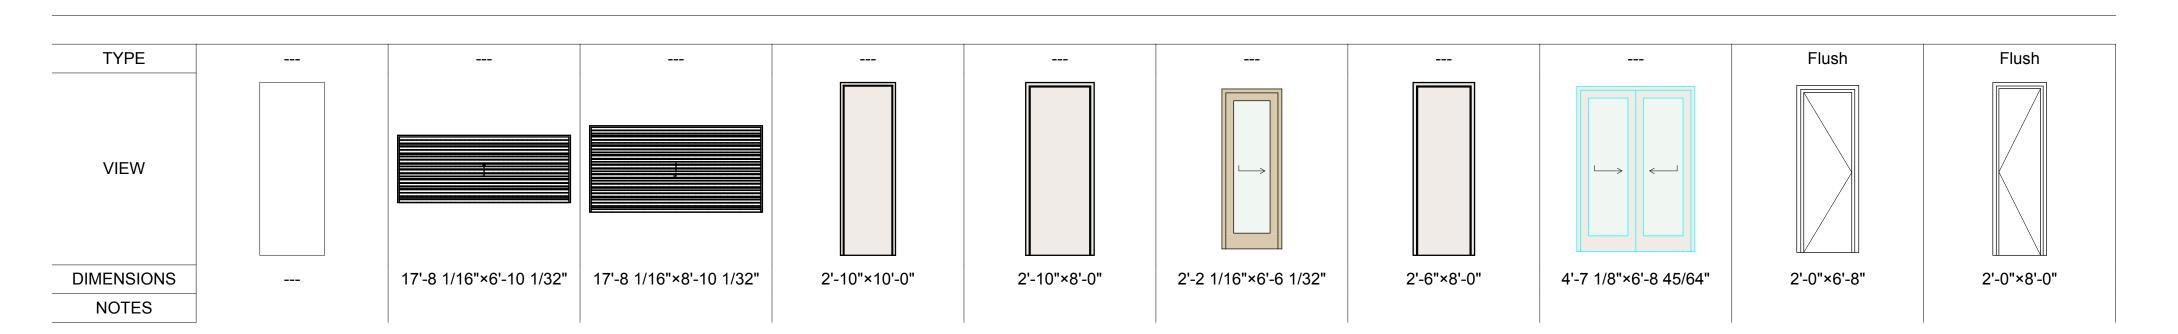



SCALE: 1' = 1'-0"

cloud hill design, llc

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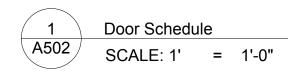
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Schedules

A501

								DOOR SO	CHEDULE					
DOOR N	UMBER				DOOR LEAF						HARD	RATING	S	
ROOM	ID	ROOM NAME	NOMINAL WIDTH	NOMINAL HEIGHT	LEAF THICKNESS	MATERIAL	TYPE	HEAD DETAIL	JAMB DETAI	L SILL DETAIL		FIRE	STC	REMARKS
	Barn		3'-0"	8'-0"	1 37/64"	SC WOOD						<undefined></undefined>		
	Barn		3'-0"	8'-0"	1 37/64"	SC WOOD						<undefined></undefined>		
	D - 1		5'-0"	8'-0"	1 3/4"	SC WOOD						<undefined></undefined>		
D.	-2 Garage		18'-0"	9'-0"	1 37/64"	SC WOOD						<undefined></undefined>		
	D-3		4'-0"	9'-0"	1 3/4"	SC WOOD						<undefined></undefined>		
	D-4		3'-0"	8'-0"	1 3/4"	SC WOOD						<undefined></undefined>		
	D-5		3'-0"	8'-0"	1 3/4"	SC WOOD						<undefined></undefined>		
	D-10		2'-6"	8'-0"	1 3/4"	SC WOOD						<undefined></undefined>		
	D-11		2'-0"	8'-0"	1 3/4"	SC WOOD						<undefined></undefined>		
	D-12		3'-6"	8'-0"	1 3/4"	SC WOOD						<undefined></undefined>		
	D-13		2'-6"	8'-0"	1 3/4"	SC WOOD						<undefined></undefined>		
	D-14		2'-8"	8'-0"	1 3/4"	SC WOOD						<undefined></undefined>		
	D-15		2'-8"	8'-0"	1 3/4"	SC WOOD						<undefined></undefined>		
	D-16		6'-0"	8'-0"	1 3/4"	SC WOOD						<undefined></undefined>		
	D-17		2'-0"	8'-0"	1 3/4"	SC WOOD						<undefined></undefined>		
	D-18		3'-0"	6'-8"	1 3/4"	SC WOOD						<undefined></undefined>		
	D-19		3'-0"	8'-0"	1 3/4"	SC WOOD						 <undefined></undefined>		
	D-20		3'-0"	7'-3"	1 3/4"	SC WOOD						<undefined></undefined>		
	D-100		2'-6"	8'-0"	1 3/4"	SC WOOD						<undefined></undefined>		
	D-101		2'-6"	8'-0"	1 1/4"	SC WOOD						<undefined></undefined>	None	
	D-102		2'-6"	8'-0"	1 1/4"	SC WOOD						<undefined></undefined>		
	D-103		2'-6"	8'-0"	1 1/4"	SC WOOD						<undefined></undefined>		
	D-104		2'-10"	10'-0"	1 1/4"	SC WOOD						<undefined></undefined>		
	D-105		2'-10"	10'-0"	1 1/4"	SC WOOD						<undefined></undefined>	None	
	D-106		5'-1 1/2"	8'-6"	1 3/4"	SC WOOD						<undefined></undefined>		
	D-107		2'-6"	8'-0"	1 3/4"	SC WOOD						<undefined></undefined>		
	D-109		2'-10"	8'-0"	1 1/4"	SC WOOD						<undefined></undefined>	None	
	D-112		5'-7"	9'-0"	1 3/4"	SC WOOD						<undefined></undefined>		
	D-112		5'-0"	6'-8"	1 3/4"	SC WOOD						<undefined></undefined>		
	D-113		3'-0"	8'-0"	1 37/64"	SC WOOD						<undefined></undefined>		
	D-113		5'-7"	9'-0"	1 3/4"	SC WOOD						<undefined></undefined>		
	D-114		2'-6"	6'-8"	1 3/4"	SC WOOD						<undefined></undefined>		
	D-115		4'-11 1/16"	6'-10 43/64"	1 37/64"	SC WOOD						<undefined></undefined>		
	D-118		2'-8"	6'-8"	1 3/4"	SC WOOD						<undefined></undefined>		
	D-121		3'-0"	6'-8"	1 3/4"	SC WOOD						<undefined></undefined>		



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MODEL FILE:


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**Door Schedules** 

A502



SCALE: 1" = 1'-0"

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Survey Peak Surveying Inc. Jason R. Neil, P.L.S.

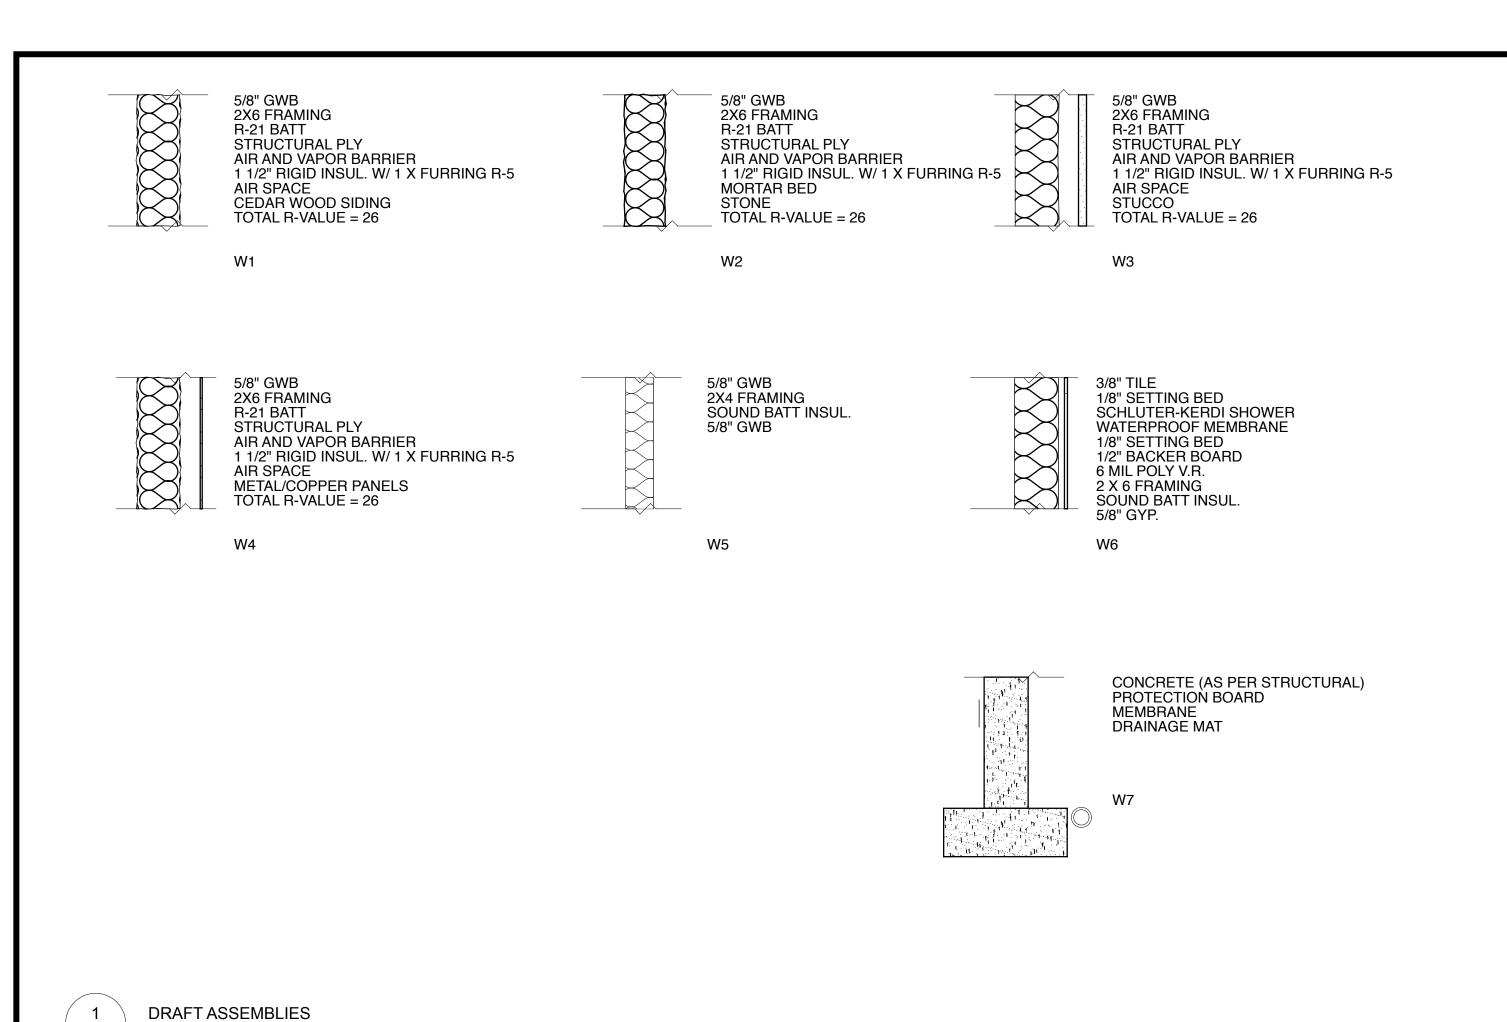Planning and Design Cloud Hill Design, LLC Jeffrey Woodruff

041 Rainbow Lane

41 Rainbow Lane Woody Creek CO 81656 M/B Woody Creek

Jennifer and Joseph Mason

Parcel ID 264308100010 Account # R003195

Date: Issue:
11/18/2021 Planning Pre-Application
01/14/2022 Schematic/Pricing

**Building Pre-Application** 

PROJECT NO: Project No. 210

MODEL FILE:
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01/18/2022

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Assemblies and Energy Use

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